

ORDINANCE NO. O-2025-14

**AN ORDINANCE GRANTING A SPECIAL USE PERMIT TO ALLOW THE CONSTRUCTION AND USE OF A 1,580 SQUARE FOOT COMMERCIAL BUILDING FOR A FAST FOOD AND DRIVE-THROUGH RESTAURANT, ON A CERTAIN PIECE OF PROPERTY COMMONLY KNOWN AS 1815 N. MAIN STREET - POPEYES**

**WHEREAS**, written application has been made requesting a special use permit pursuant to Article 18.3 of the Wheaton Zoning Ordinance to allow the construction and use of a 1,580 square foot commercial building for a fast food and drive-through restaurant, all on certain property legally described herein and commonly known as 1815 N. Main Street, Wheaton, Illinois 60187; and

**WHEREAS**, pursuant to notice as required by the Illinois Municipal Code and the Wheaton Zoning Ordinance, a public hearing was conducted by the Wheaton Planning and Zoning Board on February 25, 2025 and March 11, 2025, to consider the special use permit; and the Planning and Zoning Board has recommended approval of the special use permit.

**NOW, THEREFORE, BE IT ORDAINED** by the Mayor and City Council of the City of Wheaton, DuPage County, Illinois, pursuant to its home rule powers, as follows:

**Section 1:** The following described property has been and continues to be zoned and classified in the C-3 General Commercial District zoning classification:

LOT 2 IN BLOCK 4 IN ARTHUR T. MCINTOSH AND COMPANY'S GENEVA ROAD SUBDIVISION, BEING A SUBDIVISION IN THE NORTHWEST QUARTER OF SECTION 9, TOWNSHIP 39 NORTH, RANGE 10 EAST OF THE THIRD PRINCIPAL MERIDIAN, ACCORDING TO THE PLAT THEREOF RECORDED JUNE 26, 1924 AS DOCUMENT 179449 AND CERTIFICATE OF CORRECTION FILED AUGUST 15, 1924 AS DOCUMENT 180974, IN DUPAGE COUNTY, ILLINOIS.

P.I.N.: 05-09-108-002

The subject property is commonly known as 1815 N. Main Street, Wheaton, IL 60187.

**Section 2:** Pursuant to the Findings of Fact made and determined by the Wheaton Planning and Zoning Board, a special use permit pursuant to Article 18.3 of the Wheaton Zoning Ordinance is granted to allow the construction and use of a 1,580 square foot commercial building for a fast food and drive-through restaurant at 1815 N. Main Street, in full compliance with the following plans: "Site Plan and Signage", "Elevations and Trash Enclosure", and "Fence and Wall Details", prepared by Thomas V. Scesniak Associates, Schamburg, IL, dated March 24, 2024 and revised March 6, 2025; "Site Plan - Popeyes Louisiana Kitchen, 1815 N. Main Street, Wheaton IL", prepared by Gewalt Hamilton Associates, Inc., Vernon Hills, IL, dated December 20, 2024 and revised March 4, 2025; and "Preliminary Engineering and Landscape Plans - Popeyes Louisiana Kitchen, 1815 N. Main Street, Wheaton IL", prepared by Gewalt Hamilton Associates, Inc., Vernon Hills, IL, dated December 20, 2024, subject to the following conditions:

1. The photometrics plan shall be revised to meet code;
2. All floodplain and wetland permitting shall be authorized by DuPage County as the City of Wheaton is a partial waiver community;
3. The underground compensatory storage facility shall be constructed with proper foundations and structural engineering calculations to ensure that the proposed underground structure is

able to be built on these soils. All outside consultant review fees charged to the City in the review of such structural engineering calculations shall be charged to the applicant as a plan review fee; and

4. The preliminary engineering plan shall be subject to further staff review prior to the issuance of a site development permit.

**Section 3:** All ordinances or parts of ordinances in conflict with these provisions are repealed.

**Section 4:** This ordinance shall become effective from and after its passage, approval, and publication in pamphlet form in the manner prescribed by law.



Philip J. Suess  
Mayor

ATTEST:



Andrea Rosedale  
City Clerk

**Roll Call Vote:**

Ayes:	Councilman Weller Councilman Barbier Councilwoman Bray-Parker Councilman Brown Mayor Suess Councilman Clousing Councilwoman Robbins
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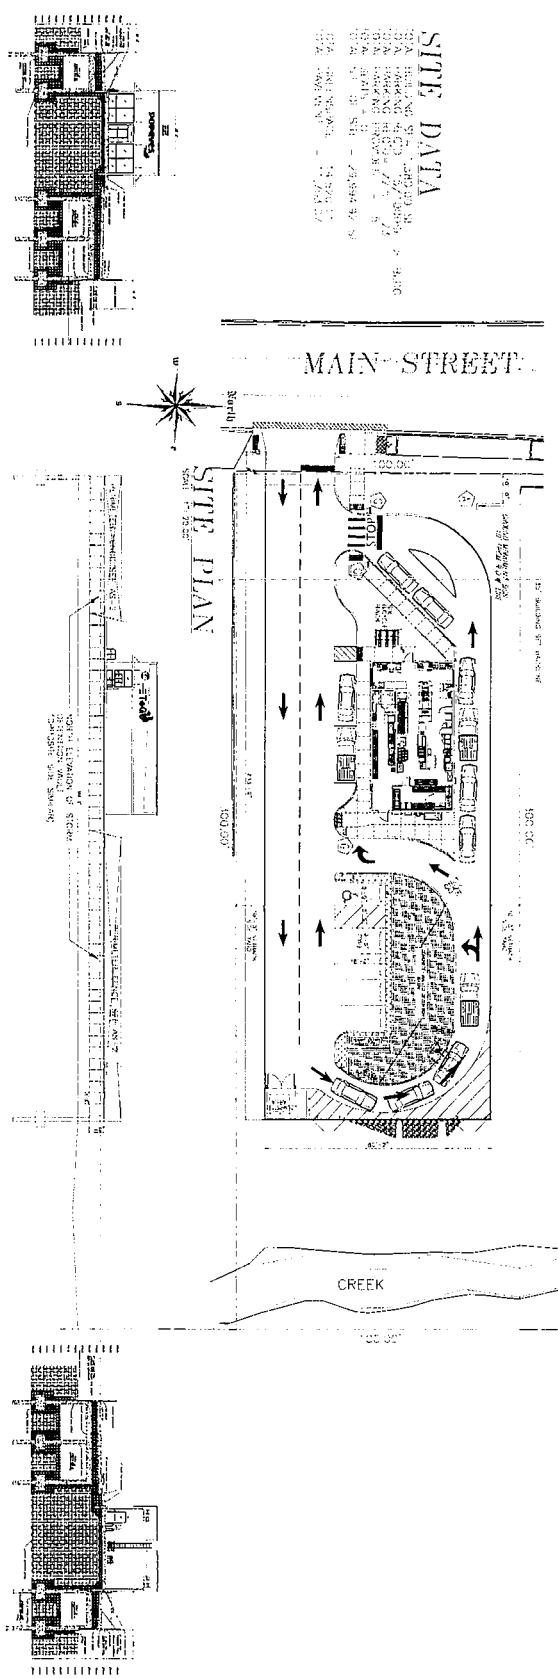
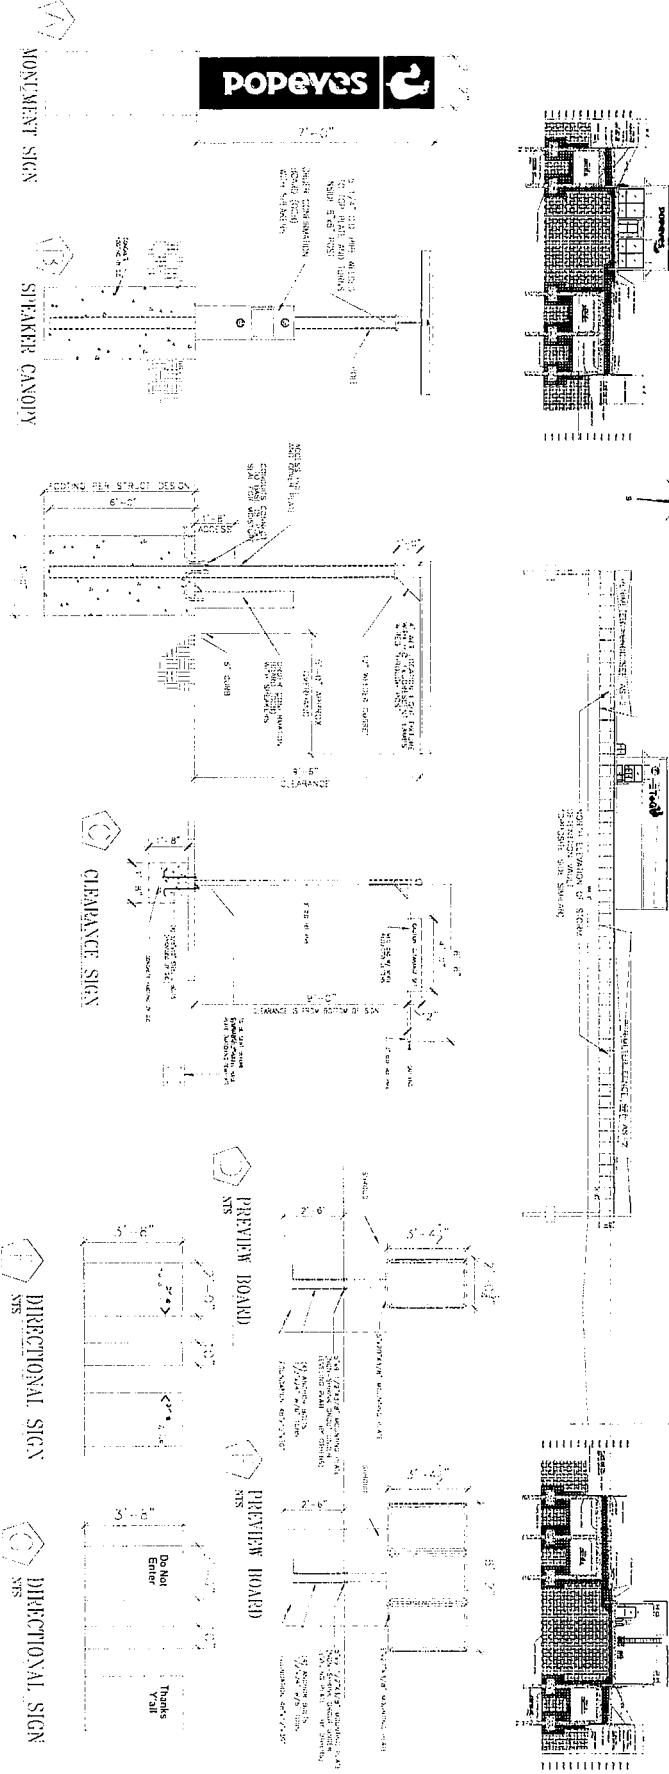
Nays:	None
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Absent:	None
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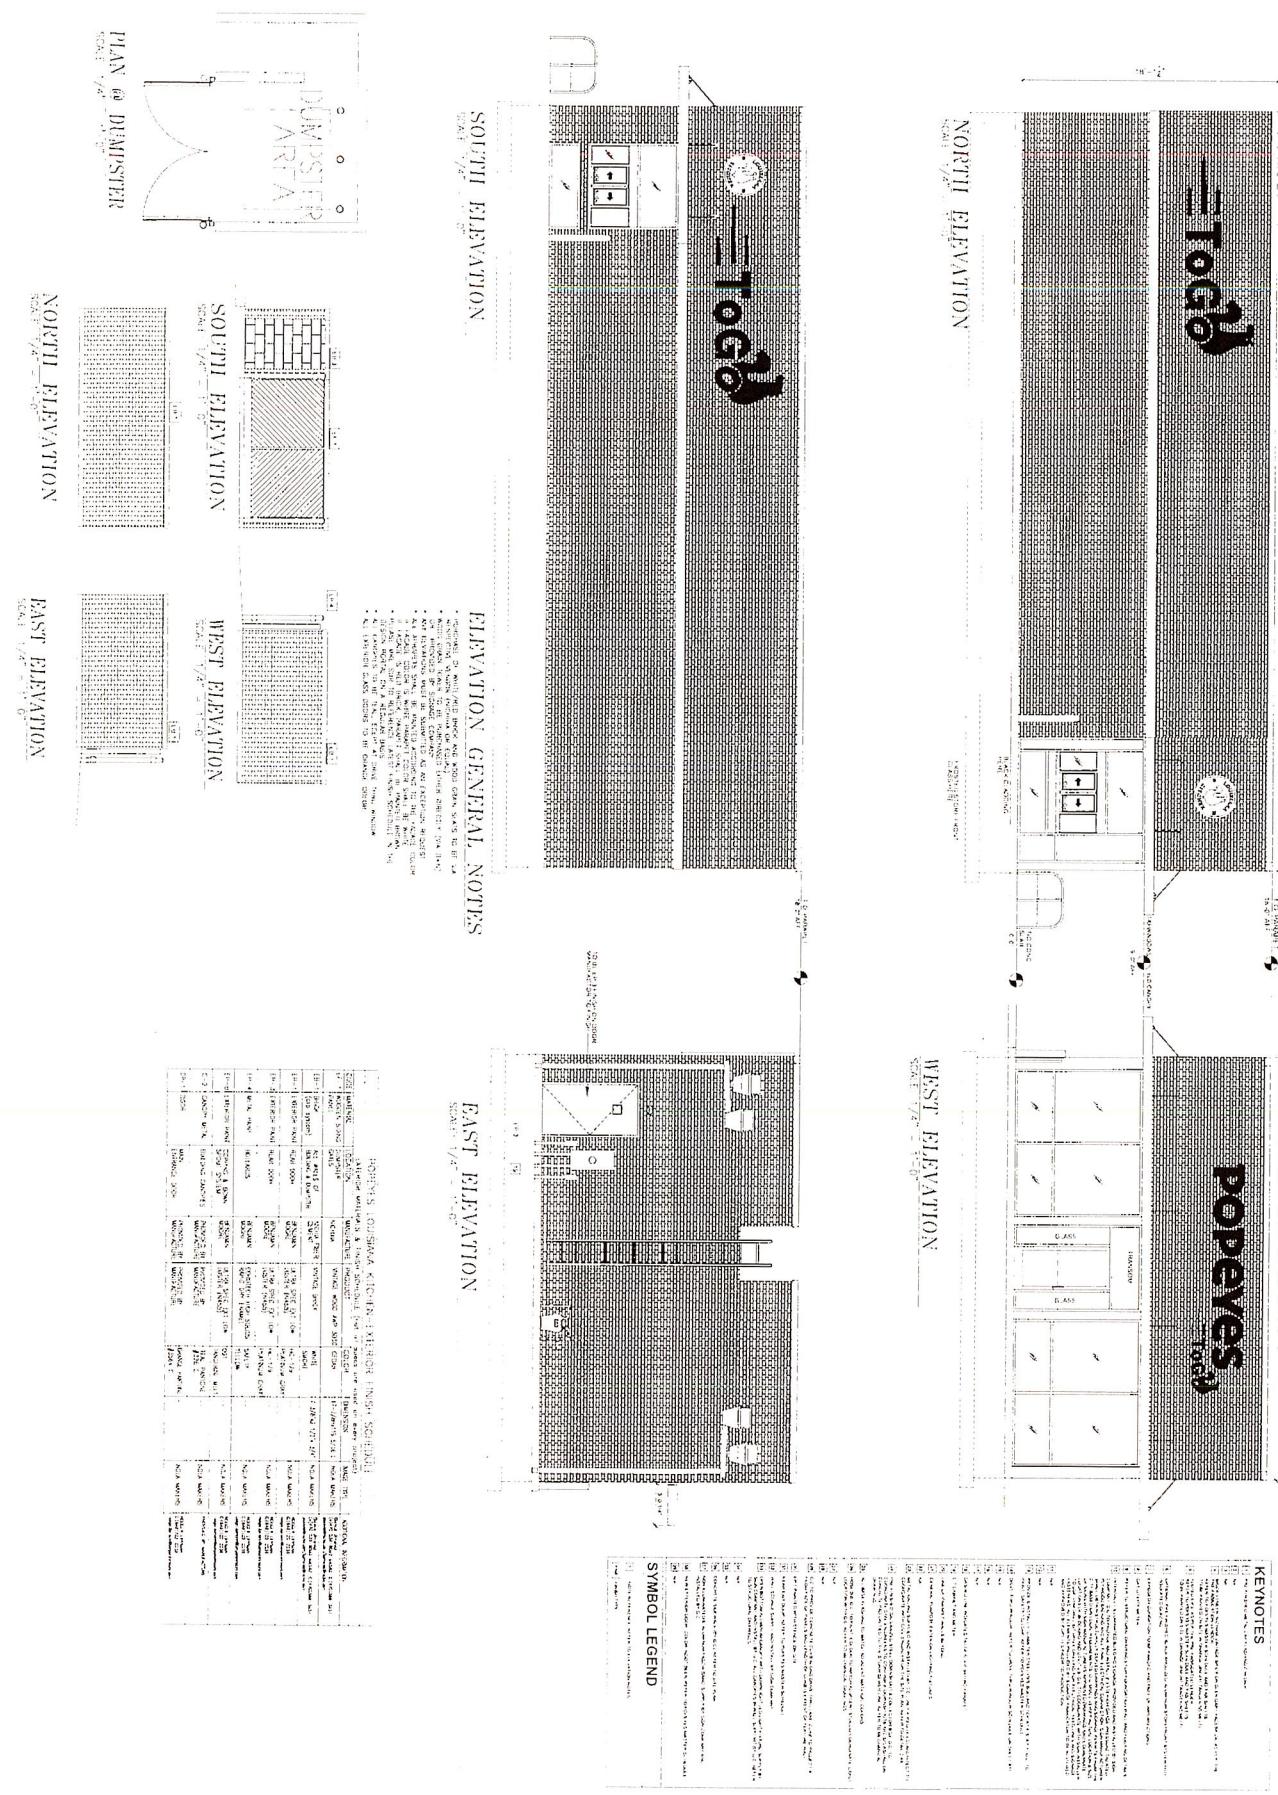
Motion Carried Unanimously

Passed: April 7, 2025

Published: April 8, 2025





THOMAS V. SCESNIAK associates  
34 New Amsterdam Street, New York 6, N.Y.  
Telephone: 6-6222, 6-6223, 6-6224, 6-6225  
Telex: 22-1111, 22-1112, 22-1113, 22-1114, 22-1115, 22-1116, 22-1117



THOMAS V. SCESNIAK associates  
1954 First Ave. West, Seattle, Washington 98101-3835  
ARCHITECTS PLANNERS ENGINEERS  
464-1252 251-1142 464-2522 251-1141 464-1252 251-1141  
e-mail: [TScesniak@Qwest.com](mailto:TScesniak@Qwest.com)

NOTCH ELEVATION

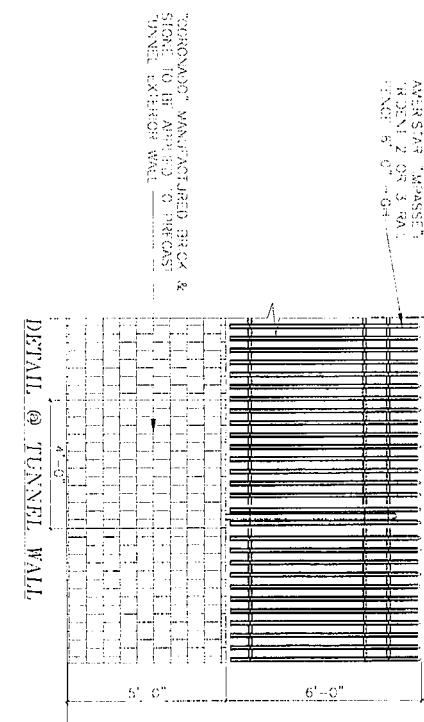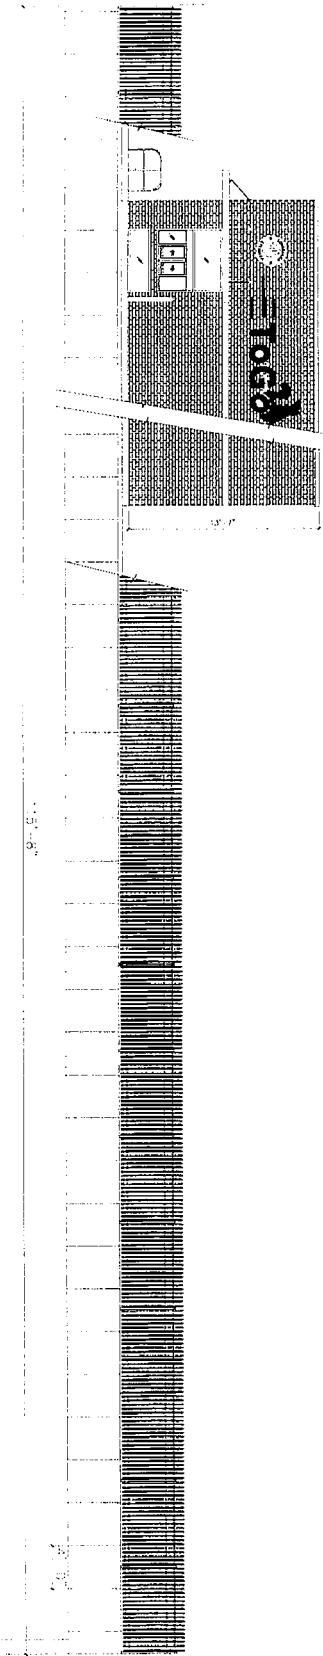

FENCE AND WALL DETAILS

AS 3400-2000  
DATE 03/24/2000  
SHEET NO. 10  
SCALE 1/4" = 1'-0"  
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PROFESSIONAL  
ENGINEERS  
IN ASSOCIATION  
1215 MAIN STREET, NORTH BAY, ONTARIO, P6A 5G1  
FOR AKBEL RAMZANALI



THOMAS V. SCESNIAK associates  
1215 Main Street, North Bay, Ontario P6A 5G1  
ARCHITECTS PLANNERS ENGINEERS  
CIVIL & STRUCTURAL MECHANICAL & ELECTRICAL

### KEY NOTES:

ALI INVOLVED


- ① PROPERTY MONUMENT GROUND SIGN, SEE ARCHITECTURAL PLANS
- ② DIGITAL MENU BOARD - ELEVATED
- ③ DIGITAL PREVIEW BOARD - SPREAD FOUNDATION ON TOP OF PLANKS
- ④ ORDER CONFIRMATION UNIT - ELEVATED
- ⑤ PICK UP WINDOW
- ⑥ CLEARANCE BAR - SPREAD FOUNDATION ON TOP OF PLANKS
- ⑦ ADA RAMP - LANDING
- ⑧ DUMPSTER ENCLOSURE FENCE
- ⑨ STOP SIGN
- ⑩ DOUBLE FACED SIGN  
STOP, NO ENTRY
- ⑪ NO ENTRY SIGN
- ⑫ DRIVE-THRU ENTER HERE / ONE WAY SIGN
- ⑬ 24" STOP BAR, WHITE PAINT
- ⑭ DIRECTIONAL ARROWS, WHITE PAINT
- ⑮ "STOP" PAYMENT LETTERS, WHITE PAINT
- ⑯ WHEEL STOP (TPR)
- ⑰ 4" PARKING STALL LINE & 4" MOBIL LINE SPACED @ 2' O.C. YELLOW PAINT
- ⑱ 4" PARKING STALL LINE, YELLOW PAINT
- ⑲ 6" LANE LINE, WHITE PAINT
- ⑳ 6" INSET CROSSWALK 1" MOE BARS, 3' O.C. WHITE PAINT
- ㉑ PICK UP ONLY LETTERING, 30' LETTERS, WHITE PAINT
- ㉒ PROPOSED UNDERGROUND COMPENSATORY STORAGE VAULT HALLS (TPR)
- ㉓ DUMPSTER ENCLOSURE  
(SEE ARCHITECTURAL PLANS)
- ㉔ DIRECTIONAL LINES, 2" YELLOW PAINT, 1' O.C.
- ㉕ DIRECTIONAL LINES, 2" YELLOW PAINT, 3' O.C.
- ㉖ CUSTOM DOUBLE-FACED SIGN,  
SEE ARCHITECTURAL PLANS  
(DO NOT ENLARGE/SHRINK)
- ㉗ 12' DOUBLE SWING GATE
- ㉘ PROTECTIVE BILLARDS
- ㉙ ADA SIGN
- ㉚ 4' GATE

**PROPOSED LEGEND**

- PCC PAVEMENT (ALT.  
PARKING PAVEMENT)
- SALVAGED PAVERS
- PCC SIDEWALK
- STREET CUT REPAIR  
(SEE DETAILS)
- GRASS & TURF RESTORATION
- NATIVE VEGETATION PLANTINGS  
(SEE LANDSCAPE PLANS)
- BUILDING
- RIP RAP, CLASS RR-3
- DETECTABLE WARNINGS
- 6" WIDE BARRIER CURB
- 6" MEDIUM BARRIER CURB (DEPR.)
- INTEGRATED SIDEWALK/ 6" WIDE BARRIER CURB
- PROTECTIVE FENCE
- PAVEMENT SAWCUT
- PERIMETER EROSION BARRIER
- RETAINING WALLS

A graphic scale and a letter 'N' are shown. The scale is marked with '12', '6', '0', and '2'. The letter 'N' is positioned above the scale.

## MAIN STREET

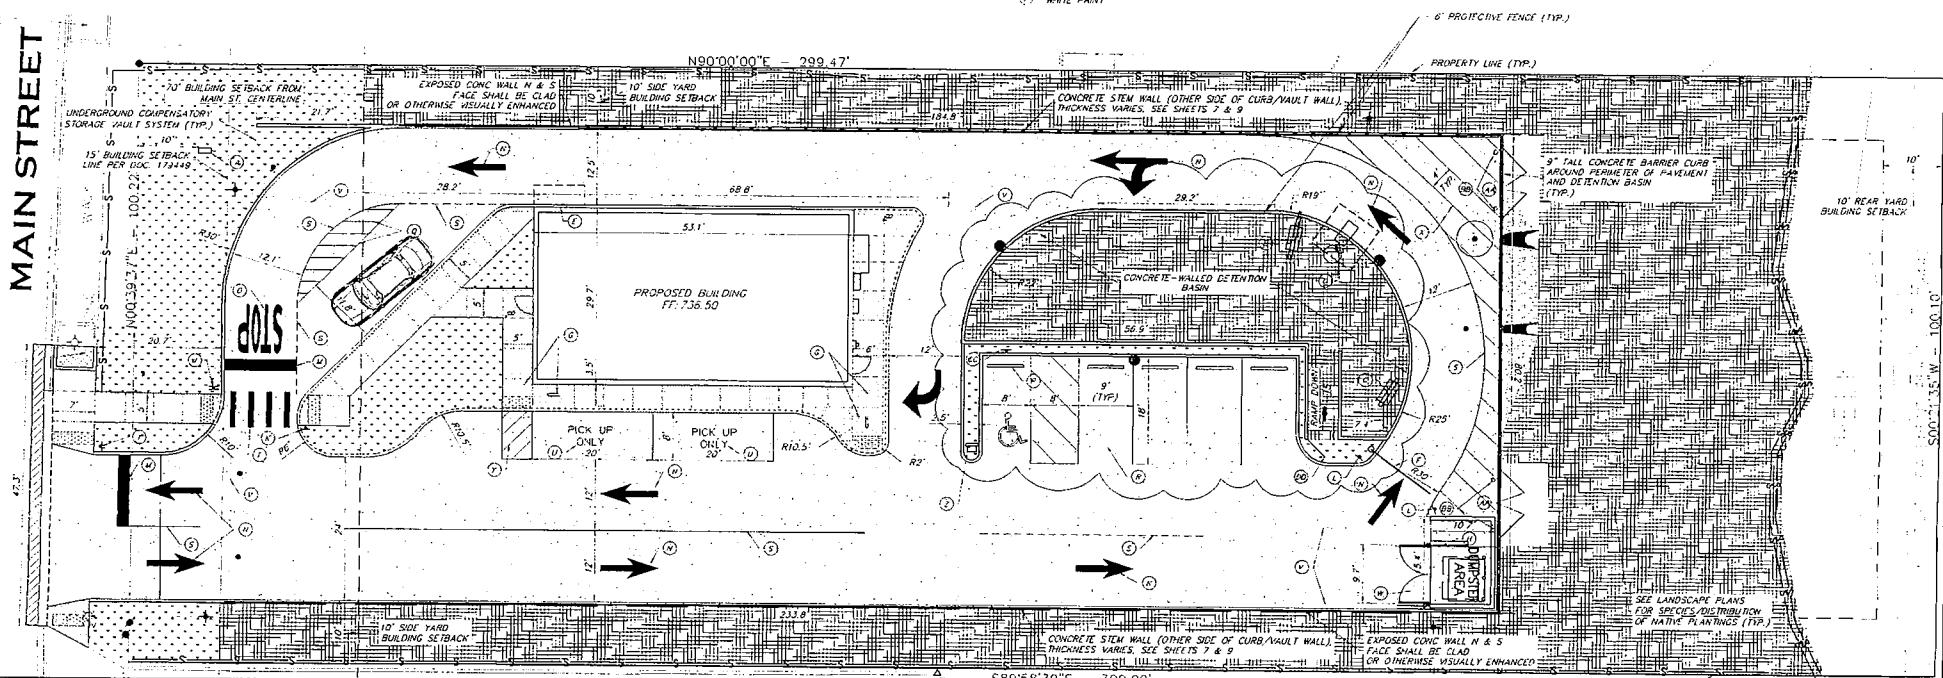

**GHA** GEWALT HAMILTON  
ASSOCIATES, INC.  
625 Forest Edge Drive • Vernon Hills, IL 60061  
(847) 823-0700 • Fax (847) 823-0701

625 Forest Edge Drive • Vernon Hills, IL 60061  
Ph 847.478.9709 • FAX 847.478.9701

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**SITE PLAN**

POPEYES LOUISIANA KITCHEN  
1815 NORTH MAIN STREET  
WHEATON, ILLINOIS

589'58"39"E - 300.00'

—  
—

EN

— 1 —


PROPERTY LINE

FILE NUMBER - 10000000000000000000000000000000		SHEET NUMBER	
DRAWN BY: R.M. GIA PROJECT #		4	
DATE: 12-31-24		DRAWN BY:	
CHECKED BY: R.M.		SCALE	
DATE: 12-31-24		DRAWN BY: R.M.	

**CITY OF WHEATON**  
**POPEYES LOUISIANA KITCHEN**

## **STANDARD SYMBOLS**

FEATURE	EXISTING	PROPOSED
BUFFALO BOX	•	•
BUSH/SHRUB	○	○
CATCH BASIN	○	○
CLEANOUT	○	○
COMBINE SEWER LINE	←	←
CONTOUR	708	708
CULVERT	→	→
DRIVEWAY/DRIVE	→	→
ELECTRIC LINE	—	—
ELECTRIC MANHOLE	○	○
FENCE	—	—
FIRE HYDRANT	—	—
FLAG END SECTION	—	—
FLAG LINE	—	—
GAS LINE	—	—
GAS MANHOLE	△	△
GAS VALVE	□	□
INLET	—	—
LIGHT POLE	—	—
OVERHEAD WIRES	—	—
POWER POLE	—	—
R.O.W. LINE	—	—
R.O.W. MARKER	—	—
SANITARY FORCEMAIN LINE	—	—
SANITARY SEWER LINE	—	—
SANITARY SEWER MANHOLE	—	—
SIDEWALK	—	—
SLOT ELEVATION	—	—
STORM SEWER LINE	—	—
STORM SEWER MANHOLE	○	○
TELEPHONE LINE	—	—
TELEPHONE MANHOLE	○	○
TELEPHONE BOX/PEDESTAL	—	—
TREE—CONIFEROUS (SIZE/TAG#)	345	345
TREE—DECIDUOUS (SIZE/TAG#)	12'	12'
VALVE BOX	○	○
VALVE VAULT	○	○
WATER VALVE	○	○
WATERMAIN LINE	—	—

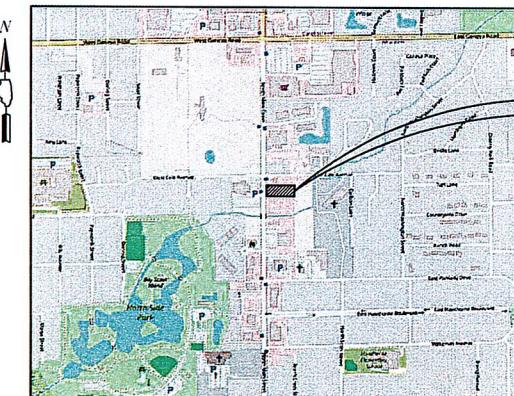

**PROJECT LOCATION**

**LOCATION MAP**  
**(Not to Scale)**

**EXISTING UTILITIES:** WHEN THE PLANS OR SPECIAL PROVISIONS INCLUDE INFORMATION PERTAINING TO THE LOCATION OF UNDERGROUND UTILITY FACILITIES, SUCH INFORMATION REPRESENTS ONLY THE OPINION OF THE ENGINEER AND THE CONTRACTOR AS TO THE LOCATION OF THESE UTILITIES FOR THE CONVENIENCE OF THE BIDDER. THE ENGINEER AND OWNER ASSUME NO RESPONSIBILITY WHATSOEVER IN RESPECT TO THE SUFFICIENCY OR ACCURACY OF THE INFORMATION PROVIDED. THE PLACES RELATIVE TO THE LOCATION OF UNDERGROUND UTILITY FACILITIES OR THE MANUFACTURERS OF THE EQUIPMENT TO BE REMOVED OR ADJUSTED, IT SHALL BE THE CONTRACTOR'S RESPONSIBILITY TO DETERMINE THE ACTUAL LOCATION OF ALL SUCH FACILITIES. HE SHALL ALSO DETERMINE THE LOCATION OF THE FACILITIES OF THE UTILITIES COMPANIES RELATIVE TO THE LOCATION OF THEIR FACILITIES AND THE WORKING SCHEDULES OF THE UTILITY COMPANIES FOR REMOVING OR ADJUSTING THEM.

CONTRACTOR IS RESPONSIBLE FOR CONTACTING J.U.L.L.E. AT 1-800-892-0123 AND MUST ACQUIRE A DIG NUMBER A MINIMUM OF 72 HOURS PRIOR TO ANY WORK BEING DONE.

**NOTE: CONSTRUCTION MEANS, METHODS AND JOB SITE SAFETY IS THE SOLE AND EXCLUSIVE RESPONSIBILITY OF THE CONTRACTOR**



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**TITLE SHEET**

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**POPEYES LOUISIANA KITCHEN  
1815 NORTH MAIN STREET  
WHEATON, ILLINOIS**

## **SHEET INDEX**

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**TOPOGRAPHIC SURVEY BY**  
WEBSTER, MCGRATH & AHLBERG, LTD.  
207 SOUTH NAPERVILLE ROAD  
WHEATON, ILLINOIS 60187  
TELEPHONE: 630-668-7603

**PROFESSIONAL DESIGN FIRM LICENSE**  
GEWALT HAMILTON ASSOCIATES, INC.  
DESIGN FIRM - LAND SURVEYOR/PROF ENG  
LICENSE NUMBER: 184.000922-0010  
EXPIRES: 6/30/2025

**PLANS PREPARED FOR**  
**R.A. SOLUTIONS, INC.**  
**1711 MAPLE AVENUE**  
**HANOVER PARK, ILLINOIS 60133**  
**TELEPHONE: 630-745-1111**  
**ATTN.: MR. AKEFEL RAMZAN**

**COORDINATING/PERMITTING**

#### COORDINATING/REMITTING AGENCIES

CITY OF WHEATON 1-630-280-2000  
DUPAGE COUNTY 1-630-407-8500  
US ARMY CORPS OF ENGINEERS 1-312-848-5530

SIGNED: DONALD E. DIXON P.E.  
DATE: DECEMBER XX, 2024  
ILLINOIS LICENSE NO.: 062-051136  
EXPIRATION DATE: NOVEMBER 30, 2025



CITY REVIEW SET

FILE #5828.000-Popeyes Wheaton-DT.dwg		SHEET NUMBER:
DRAWN BY: TLM	GHA PROJECT #	1
DATE 12-20-24	5828.000	
CHECKED BY: AJP	SCALE:	OF 19 SHEETS
DATE 12-20-24	N.A.	

EXISTING CONDITION AND DEMOLITION NOTES

1. PRIOR TO STARTING ANY CONSTRUCTION, PROVIDE SOIL EROSION AND SEDIMENT CONTROL DEVICES AS SHOWN ON THE PLANS AND AS REQUIRED PER IEPA NPDES GUIDELINES. REFER TO NOTES AND DETAILS THROUGHOUT THE ENTIRE PLAN SET.
2. CONTRACTOR SHALL REFER TO SUBSURFACE SOIL EXPLORATION REPORT.
3. NINE MILE STREET IS UNDER THE JURISDICTION OF THE CITY OF WHEATON. ALL WORK WITHIN THE RIGHT OF WAY WILL REQUIRE A PERMIT.
4. THE CONTRACTOR SHALL BE RESPONSIBLE FOR FENCING THE ACTIVE WORK ZONE FROM THE PUBLIC AND PROTECTING THE PUBLIC FROM ANY CONSTRUCTION RELATED HAZARDS TO A MINIMUM. ALL EXCAVATION, DEMOLITION AREAS AND OTHER AREAS POTENTIALLY HAZARDOUS TO PEDESTRIANS AND VEHICLES MUST BE PROTECTED.
5. AT ALL TIMES, MAIN STREET SHALL REMAIN OPEN AND UNOBSTRUCTED. TEMPORARY SHUT DOWN OF ONE TRAFFIC LANE AT A TIME WILL BE PERMITTED FOR SHORT TERM PERIODS AND SHALL BE COORDINATED WITH APPOINTED PROPERTY OWNER CONSTRUCTION STAFF. SHORT TERM CLOSURES SHALL BE COMPLETED WITHIN THE WORK DAY AND RESTORED TO UNOBSTRUCTED ACCESS BY THE CLOSE OF THE WORK DAY.
6. TEMPORARY STONE OR ASBESTOS PATHWAYS SHALL BE PROVIDED AS NEEDED THROUGHOUT THE COURSE OF CONSTRUCTION TO FACILITATE SITE ACCESS AND PERSONNEL MOVEMENT. THE LONGITUDINAL SLOPE OF SUCH PATHS SHALL NOT EXCEED 5% AND CROSS SLOPES SHALL NOT EXCEED 2%. PROVIDE 8" CA-6 BASE AND 2" SURFACE ASPHALT.
7. THE CONTRACTOR IS RESPONSIBLE FOR THE DEMOLITION AND DISPOSAL OF ALL EXISTING IMPROVEMENTS ON SITE NECESSARY TO COMPLETE THE JOB. THESE IMPROVEMENTS INCLUDE, BUT ARE NOT LIMITED TO, EXISTING PAVEMENTS, CURBS, SIDEWALKS, FENCES, AND OTHER STRUCTURES WITHIN THE WORK AREA. EXCAVATE AND GRADE TO PROPOSED PAVEMENT AND BUILD SUBGRADE GRADES (REFER TO FOUNDATION PLANS). PROPOSED PAVEMENTS AND GRADES SHALL BE COMPLETELY REMOVED AND LEGALLY DISPOSED OF OFFSITE. APPROVAL FROM THE PROJECT ENGINEER SHALL BE OBTAINED PRIOR TO REMOVING ANY EXISTING ITEMS NOT SHOWN OR MARKED FOR REMOVAL ON THIS SHEET.
8. REMOVE EXISTING UTILITIES AS SHOWN. UTILITIES THAT ARE REMOVED, UNLESS OTHERWISE NOTED, SHALL BE BACKFILLED WITH CA-6 CRUSHED STONE IN LISTS OF 6" OR LESS AND COMPACTED TO 95% MODIFIED PROCTOR DENSITY.
9. THE CONTRACTOR SHALL INCLUDE ALL ASSOCIATED COSTS WITH THE REMOVAL, TRANSPORT, DISPOSAL, TESTING AND CERTIFICATION OF "UNCONTAMINATED SOIL" AS DEFINED UNDER 415 ICS 5/3/160 INCLUDING ANY FEES, TAXES, OR SURCHARGES CHARGED BY OR THROUGH THE OPERATOR(S) OF CLEAN CONSTRUCTION OR DEMOLITION DEBRIS FILL OPERATIONS OR UNCONTAMINATED SOIL FILL OPERATIONS FOR THE ACCEPTANCE OF THE SOIL FOR DISPOSAL.
10. ALL VEGETATION AND LANDSCAPED AREAS NOT SHOWN REMAINING SHALL BE REMOVED AND DISPOSED OF OFFSITE PROPERLY. REFER TO LANDSCAPE PLANS FOR DETAILED INFORMATION ON PLANTING REMOVALS AND TRANSPLANTS.
11. THE CONTRACTOR SHALL SUBMIT TO THE OWNER AND / OR CITY A CONSTRUCTION STAGING AND FENCING PLAN. PEDESTRIAN ACCESS CONFORMING TO ADA STANDARDS SHALL BE MAINTAINED ON ALL ADA ROUTES IMPACTED BY CONSTRUCTION AT ALL TIMES.
12. CONTRACTOR TO STRIP EXISTING TOPSOIL AND STOCKPILE IN THE LOCATION SHOWN ON THE PLANS. PRIOR TO FINAL PLACEMENT OF TOPSOIL THE TOPSOIL SHALL BE PULVERIZED ON-SITE.
13. EXISTING CONDITION SURVEY PROVIDED BY WEBSTER, McCGRATH & AHLBERG, LTD. DATED AUGUST 7<sup>th</sup>, 2017.

**REMOVAL LEGEND**

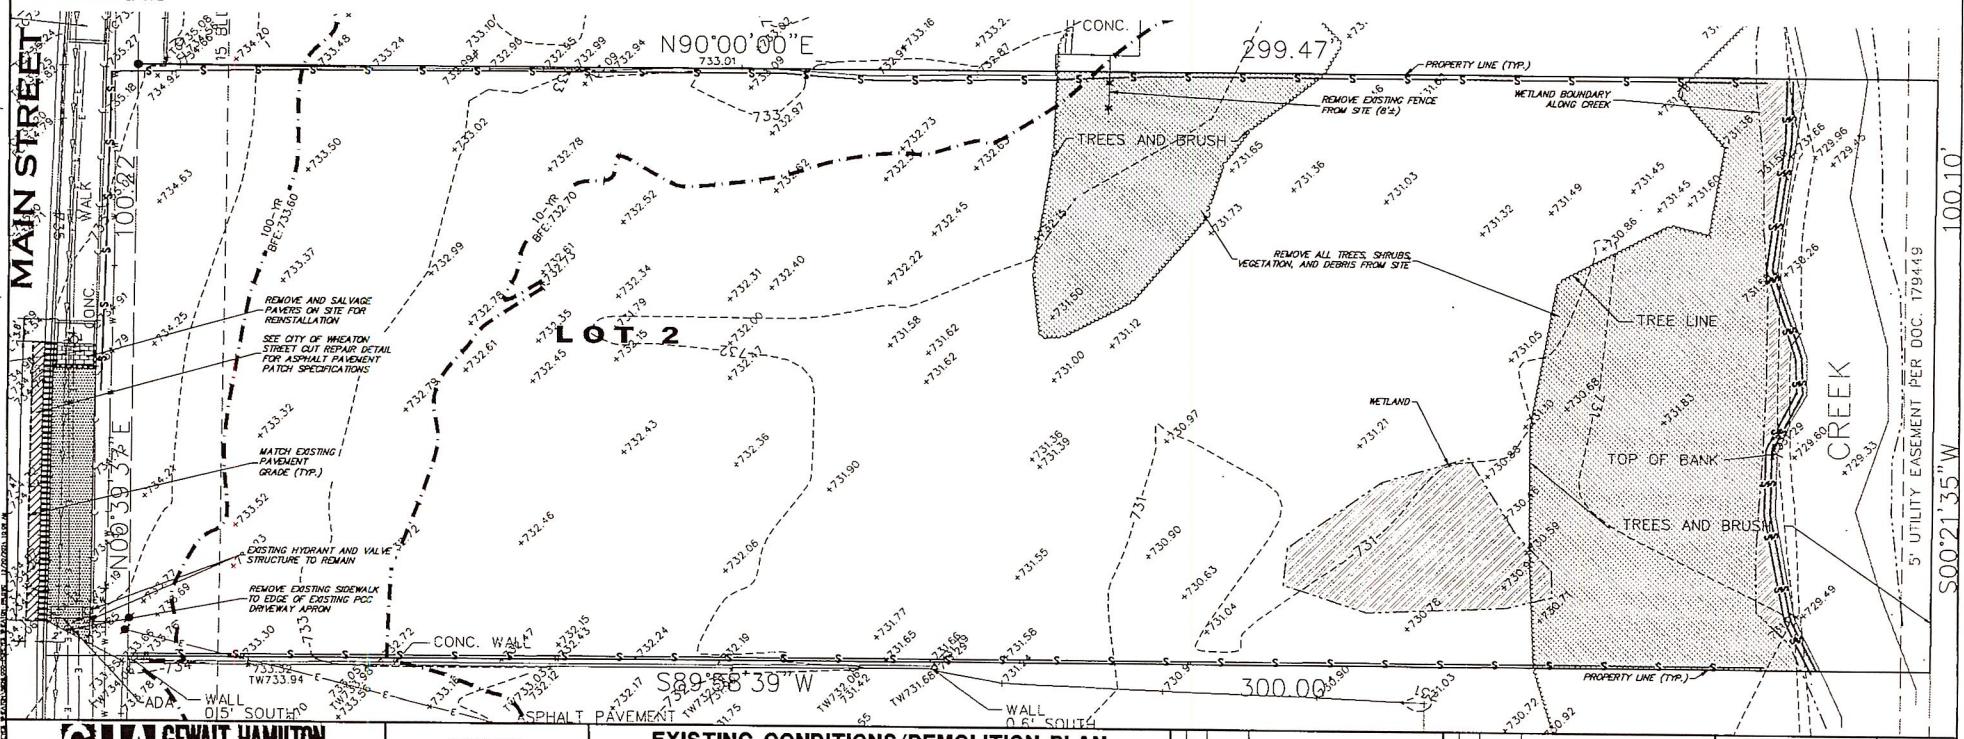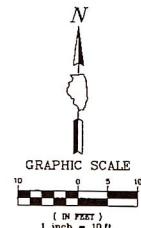

**GHA GEWALT HAMILTON  
ASSOCIATES, INC.**  
625 Forest Edge Drive ■ Vernon Hills, IL 60061  
TEL 847.478.9700 ■ FAX 847.478.9701

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## EXISTING CONDITIONS/DEMOLITION PLAN

**POPEYES LOUISIANA KITCHEN**  
**1815 NORTH MAIN STREET**  
**WHEATON, ILLINOIS**

#### UTILITY PLAN NOTES


1. THE CONTRACTOR SHALL VERIFY THE EXACT LOCATION AND ELEVATION OF EXISTING UTILITIES PRIOR TO INITIATING WORK. ANY DISCREPANCIES FOUND BETWEEN THE INFORMATION NOTED ON THE PLANS AND ACTUAL FIELD CONDITIONS, OR ANY CONFLICTS WITH PROPOSED IMPROVEMENTS SHALL BE REPORTED TO THE ENGINEER IMMEDIATELY. THE CONTRACTOR SHALL NOT PROCEED ANY FURTHER UNTIL GIVEN WRITTEN CLARIFICATION ON HOW TO PROCEED.
2. INSTALL STORM SEWER AS SHOWN. REFER TO STORM SEWER REQUIREMENT TABLE ON GENERAL NOTES SHEET FOR PIPE MATERIAL, JOINT, FRAME AND GRATE, STONE BEDDING AND TESTING REQUIREMENTS.
3. INSTALL SANITARY SEWER AS SHOWN. REFER TO SANITARY SEWER REQUIREMENT TABLE ON GENERAL NOTES SHEET FOR PIPE MATERIAL, JOINT, FRAME AND GRATE, STONE BEDDING AND TESTING REQUIREMENTS.
4. INSTALL WATERMAIN AS SHOWN. REFER TO WATER MAIN REQUIREMENT TABLE ON GENERAL NOTES SHEET FOR PIPE MATERIAL, JOINT, FRAME AND GRATE, VALVES, FIRE HYDRANT, STONE BEDDING AND TESTING REQUIREMENTS.
5. CONTRACTOR SHALL PROVIDE THE FOLLOWING AS-CONSTRUCTED DOCUMENTS AT THE CONCLUSION OF THE PROJECT:
  - a. WATER MAIN
  - AS-CONSTRUCTED LOCATION OF ALL BENDS, TEES, VALVES, COPPER UNIONS, ETC. (MEASURED DIMENSION FROM TWO FIXED ABOVE GRADE OBJECTS ARE REQUIRED FOR BURIED OBJECTS)
  - PROVIDE ALL TESTING DOCUMENTATION
- b. SANITARY SEWER
- AS-CONSTRUCTED LOCATIONS OF STRUCTURES, SERVICE CONNECTIONS, CLEANDOUTS.
- RIM AND INVERT ELEVATIONS.
- COLOR VIDEO WITH TRANSCRIPT REQUIRED FOR NEW SEWER LINES INSTALLED.
- c. STORM SEWER
- AS-CONSTRUCTED LOCATIONS OF STRUCTURES, SERVICE CONNECTIONS, CLEANDOUTS.
- RIM AND INVERT ELEVATIONS.

6. REFER TO MEP AND ARCHITECTURAL PLANS FOR ELECTRIC AND GAS REQUIREMENTS AND FINAL ROUTING.


7. THE CONTRACTOR SHALL INCLUDE ALL ASSOCIATED COSTS WITH THE REMOVAL, TRANSPORT, DISPOSAL, TESTING AND CERTIFICATION OF UNCONTAMINATED SOIL AS DEFINED UNDER ILLCS 5/3-160 INCLUDING ANY FEES, TAXES, OR SURCHARGES CHARGED BY OR THROUGH THE OPERATOR(S) OF CLEAN CONSTRUCTION OR DEMOLITION DEBRIS FILL OPERATIONS OR UNCONTAMINATED SOIL FILL OPERATIONS FOR THE ACCEPTANCE OF UNCONTAMINATED SOIL.

#### UTILITY PLAN LEGEND

—	EXISTING STORM SEWER
—	EXISTING SANITARY SEWER
—	EXISTING WATERMAIN
—	PROPOSED STORM SEWER
—	PROPOSED SANITARY SEWER
—	PROPOSED WATERMAIN
EXISTING	PROPOSED
—	STORM MANHOLE
○	STORM CATCHBASIN
□	STORM INLET
—	FLARED END SECTION
○	SANITARY MANHOLE
□	VALVE VAULT
●	VALVE BOX
○	BUFFALO BOX
+	STREET LIGHT
4	SIGN

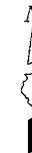

GRAPHIC SCALE  
(1 INCH = 10 FT)

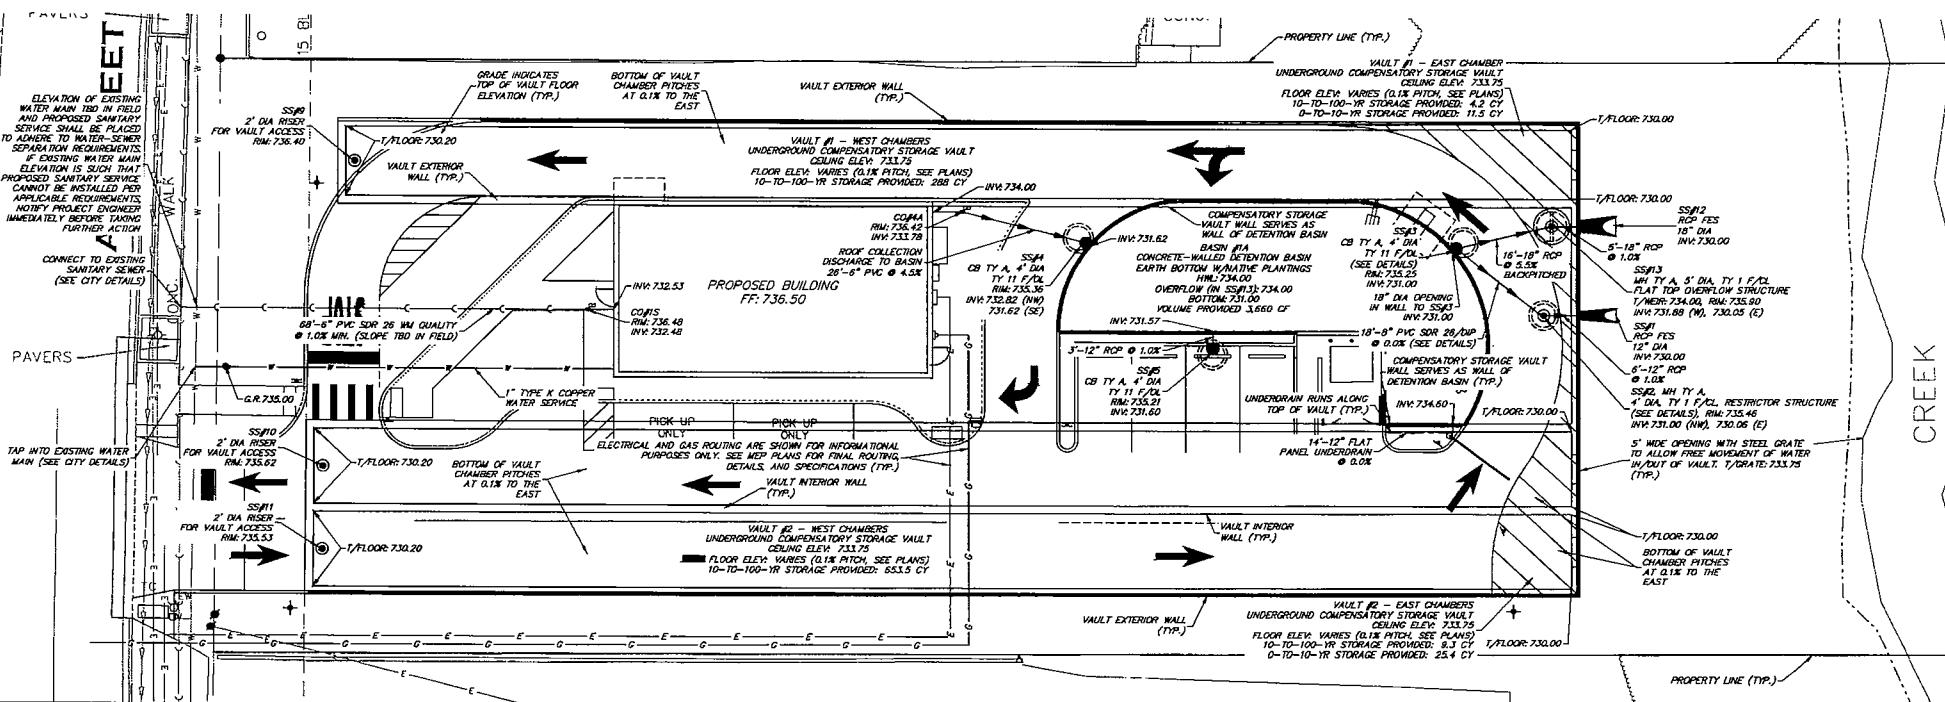


**GHA GEWALT HAMILTON  
ASSOCIATES, INC.**  
625 Forest Edge Drive ■ Vernon Hills, IL 60061  
Tel: 847.478.9700 ■ Fax 847.478.9701

#### UTILITY PLAN

POPEYES LOUISIANA KITCHEN  
1815 NORTH MAIN STREET  
WHEATON, ILLINOIS

PL 3823.000-Popeyes Wheaton-Orland	5
DRAWN BY: TLM DATE: 12-20-24 GHA-PROJECT # 5B29.000	OF 19 SHEETS
CHECKED BY: AJP DATE: 12-20-24 SCALE 1" = 10'	



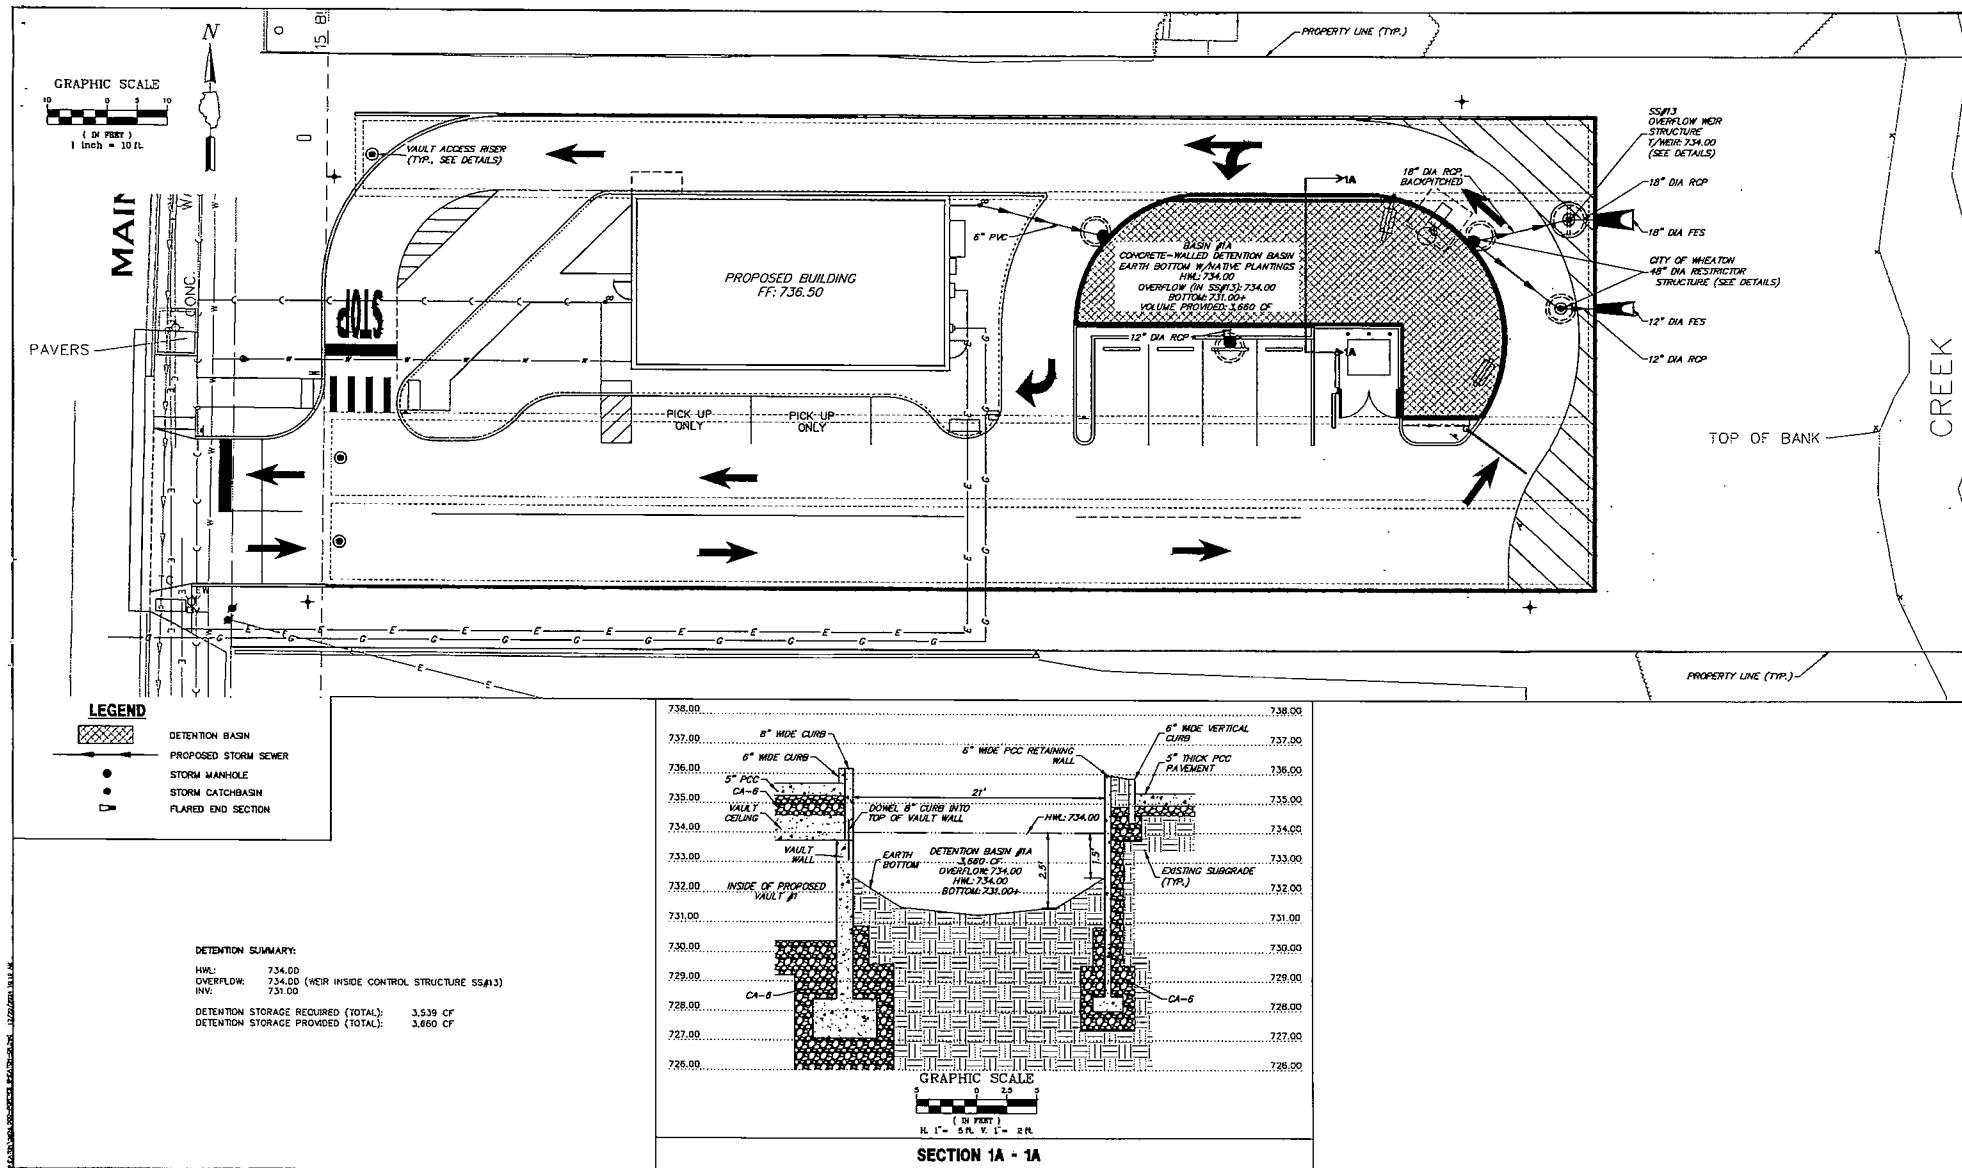


**GRADING PLAN NOTES**

1. PRIOR TO STARTING ANY CONSTRUCTION, PROVIDE SOIL EROSION AND SEDIMENT CONTROL DETAILS AS SHOWN ON THE PLANS AND AS REQUIRED PER IEPQA NPDES GUIDELINES. REFER TO NOTES AND DETAILS THROUGHOUT THE ENTIRE PLAN SET.
2. PRIOR TO STARTING ANY EXCAVATION WORK, PROVIDE TREE PROTECTION, PRESERVATION AND ROOT PRUNING AS SHOWN ON THE PLANS AND NOTES THROUGHOUT THE ENTIRE PLAN SET.
3. CONTRACTOR SHALL REFER TO SUBSURFACE SOIL EXPLORATION REPORT.
4. REFER TO GENERAL NOTES FOR GRADING, COMPACTION AND PROOF ROLL REQUIREMENTS.
5. HANDICAP ACCESSIBLE PARKING SPACES SHALL BE CONSTRUCTED BETWEEN 1.0X AND 1.2X SLOPES IN ANY ONE DIRECTION. ILLINOIS ACCESSIBILITY CODE PERMITS MAXIMUM CONSTRUCTED SLOPE OF 2.0%.
6. CRUSHED CONCRETE MAY NOT BE USED FOR THIS PROJECT WITHOUT PRIOR WRITTEN APPROVAL FROM PROJECT ENGINEER.
7. THE CONTRACTOR SHALL REMOVE OR EXPORT SOIL AS NECESSARY TO CONSTRUCT THE SITE TO SPECIFIED PLAT GRADES. SUCH WORK IS CONSIDERED INCIDENTAL TO THE CONTRACT AND NO ADDITIONAL COMPENSATION SHALL BE ALLOWED FOR SUCH WORK. MINOR ADJUSTMENTS TO GRADES CAN BE ACCOMMODATED WITH PROJECT ENGINEER APPROVAL.
8. THE CONTRACTOR SHALL INCLUDE ALL ASSOCIATED COSTS WITH THE REMOVAL OF EXISTING SOILS, TESTS AND CERTIFICATION OF UNCONTAMINATED SOIL AS DEFINED UNDER 41 ILL. REG. 5/2160, INCLUDING ANY FEES, TAXES, OR CHARGES CHARGED BY OR THROUGH THE OPERATORS OF CLEAN UP/DEMOLITION OR DEMOLITION DEBRIS FILT OPERATIONS OR UNCONTAMINATED SOIL FILT OPERATIONS FOR THE ACCEPTANCE OF UNCONTAMINATED SOIL.
9. REFER TO SOIL EROSION AND SEDIMENT CONTROL NOTES AND DETAILS FOR SEED AND BLANKET REQUIREMENTS FOR TEMPORARY STABILIZATION.
10. REFER TO GEOMETRIC PLAN FOR FINAL RESTORATION REQUIREMENTS.

11. CONTRACTOR SHALL PROVIDE THE FOLLOWING AS-CONSTRUCTED DOCUMENTS AT THE CONSTRUCTION AND THE PRE-OPERATION STAGES:

- STORMWATER BASINS AND VAULTS
  - OVERFLOW, WEIR, AND BOTTOM OF BASIN ELEVATIONS
  - STRUCTURE, PIPE, AND FLARED END SECTIONS ELEVATIONS WITHIN BASIN
  - CONTROL STRUCTURE RESTRICTOR SIZE AND ELEVATION.
  - AS-CONSTRUCTED VOLUMES WITHIN RESPECTIVE BASINS UP TO OVERFLOW

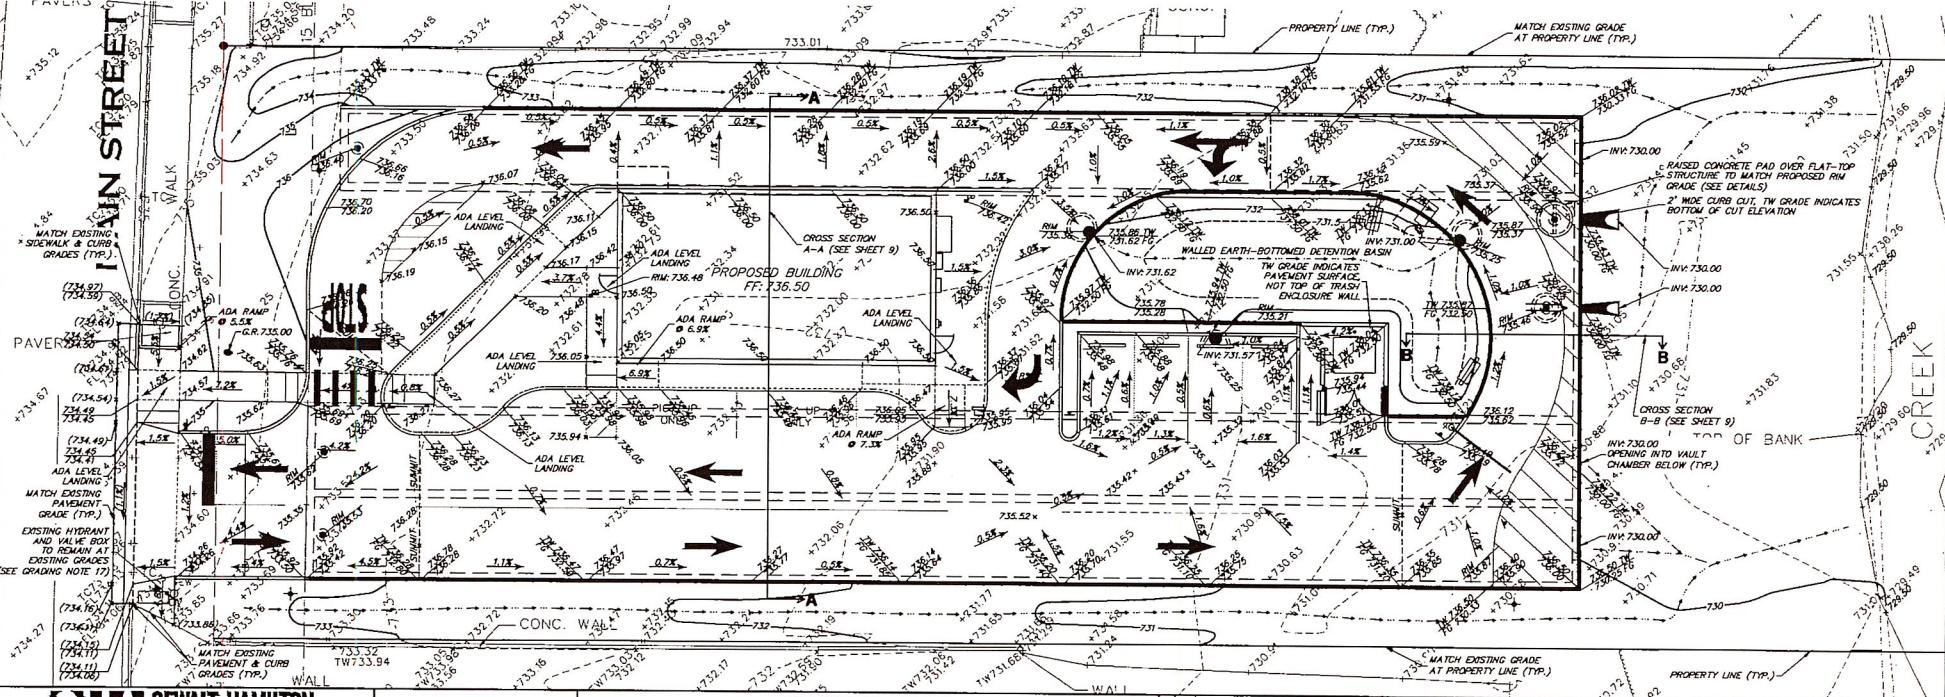

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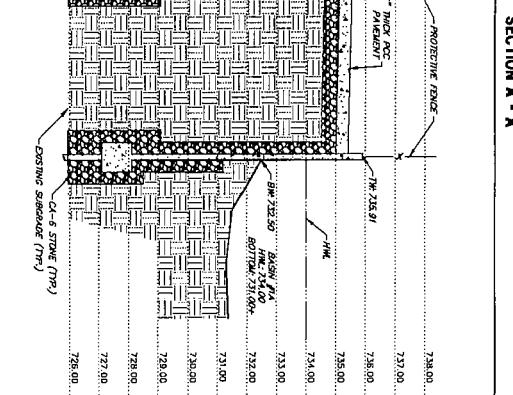
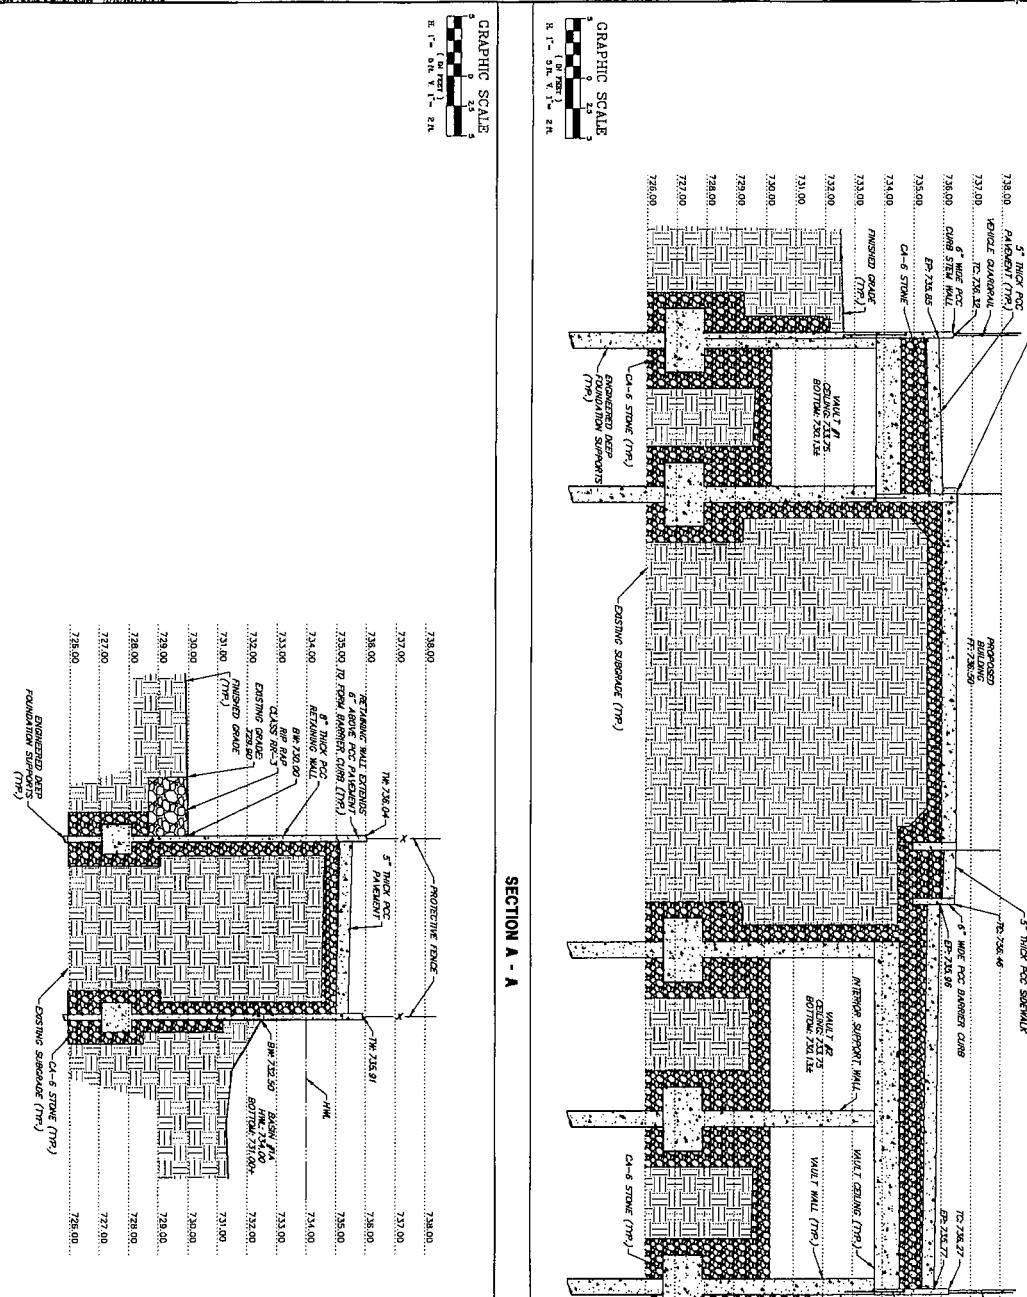
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## GRADING PLAN

POPEYES LOUISIANA KITCHEN  
1815 NORTH MAIN STREET  
WHEATON, ILLINOIS

RE 5828.000-Polymer Reactor-DR-01  
 DRAWN BY: TLM GHA PROJECT # 5828.000  
 DATE 12-20-24  
 CHECKED BY: A.P. DATE 12-20-24 SCALE 1" = 10'  
 NO. BY DATE REVISION NO. BY DATE REVISION  
 SHEET NUMBER  
 8  
 OF 19 SHEETS

SHEET NUMBER  
**8**  
as 19



222

## GRADING PLAN CROSS SECTIONS

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**GRADING PLAN CROSS SECTION**

**CROSS SECTIONS**





#### GENERAL NOTES

1. ALL CONSTRUCTION SHALL BE PERFORMED ACCORDING TO THE ILLINOIS DEPARTMENT OF TRANSPORTATION "STANDARD SPECIFICATIONS FOR ROAD AND BRIDGE CONSTRUCTION" LATEST EDITION, THE "STANDARD SPECIFICATIONS AND RECURRING SPECIAL PROVISIONS" LATEST EDITION, THE "STANDARD SPECIFICATIONS FOR WATER AND SEWER MAIN CONSTRUCTION IN ILLINOIS" LATEST EDITION, THE ILLINOIS PLUMBING CODE, THE STATE AND LOCAL ORDINANCES APPLICABLE TO THE PROJECT, ALL APPLICABLE REQUIREMENTS OF THE ILLINOIS DEPARTMENT OF TRANSPORTATION, THE EPA AND ORDINANCES OF AUTHORITIES HAVING JURISDICTION AND ALL ADDENDA THERETO.
2. EASEMENTS FOR THE EXISTING UTILITIES, BOTH PUBLIC AND PRIVATE AND UTILITIES WITHIN PUBLIC RIGHTS-OF-WAY ARE SHOWN ON THE PLANS ACCORDING TO AVAILABLE RECORDS. THE CONTRACTOR SHALL NOTIFY THE ENGINEER IMMEDIATELY OF ANY PROBLEMS IN THE FIELD OF THESE UTILITIES LINES AND THEIR PROTECTION FROM DAMAGE DUE TO CONSTRUCTION OPERATIONS. IF EXISTING UTILITY LINES OF ANY NATURE ARE ENCOUNTERED WHICH CONFLICT WITH NEW CONSTRUCTION, THE CONTRACTOR SHALL NOTIFY THE ENGINEER IMMEDIATELY SO THAT THE CONFLICT MAY BE RESOLVED.
3. WHENEVER, DURING CONSTRUCTION OPERATIONS, ANY LOOSE MATERIAL IS DEPOSITED IN THE FLOW LINE OF GUTTERS, DRAINAGE STRUCTURES, DITCHES, ETC. SUCH THAT THE NATURAL FLOW LINE OF WATER IS OBSTRUCTED, THE CONTRACTOR SHALL REMOVE THE MATERIAL EACH WORKING DAY. AT THE CONCLUSION OF CONSTRUCTION OPERATIONS, ALL DRAINAGE STRUCTURES AND FLOW LINES SHALL BE FREE FROM DIRT AND DEBRIS. THIS WORK SHALL BE CONSIDERED INCLUDED IN THE CONTRACT PRICE. THE CONTRACTOR SHALL NOT BE PROVIDED THE ABOVE WILL PRECLUDE ANY POSSIBLE ADDED COMPENSATION REQUESTED DUE TO DELAYS OR UNSUITABLE MATERIALS CREATED AS A RESULT THEREOF.
4. THE CONTRACTOR SHALL VERIFY ALL DIMENSIONS AND EXISTING CONDITIONS AFFECTING THEIR WORK WITH THE ACTUAL CONDITIONS AT THE JOB SITE PRIOR TO ORDERING MATERIALS. IN ADDITION, THE CONTRACTOR MUST VERIFY THE LINE AND GRADES. IF THERE ARE ANY DISCREPANCIES FROM WHAT IS SHOWN ON THE CONTRACTOR SHALL NOTIFY THE ENGINEER OF THE DISCREPANCIES AND, IF SPECIAL DETAILS, THE CONTRACTOR SHALL SECURE WRITTEN INSTRUCTION FROM THE ENGINEER. IF THE CONTRACTOR FAILS TO SECURE SUCH INSTRUCTION, THE CONTRACTOR WILL BE CONSIDERED TO HAVE PROCEEDED AT HIS/HER OWN RISK AND EXPENSE AND NO ADDITIONAL COMPENSATION WILL BE PROVIDED FOR ANY COSTS INCURRED.
5. ALL PAVEMENT DIMENSIONS ARE SHOWN TO EDGE OF PAVEMENT UNLESS OTHERWISE NOTED.
6. WHERE SECTION OR SUBSECTION MONUMENTS ARE ENCOUNTERED, THE ENGINEER SHALL BE NOTIFIED BEFORE THE MONUMENTS ARE REMOVED. THE CONTRACTOR SHALL CAREFULLY PRESERVE ALL PROPERTY MARKS AND MONUMENTS UNTIL THE OWNER, AUTHORIZED SURVEYOR OR AGENT HAS WITNESSED OR OTHERWISE REFERENCED THEIR LOCATION.
7. THE CONTRACTOR SHALL NOTIFY THE ENGINEER AT LEAST 72 HOURS PRIOR TO BEGINNING WORK.
8. IF DURING CONSTRUCTION THE CONTRACTOR ENCOUNTERS OR OTHERWISE BECOMES AWARE OF ANY SEWERS OR UNDERDRAINS OTHER THAN THOSE SHOWN ON THE PLANS, HE/SHE SHALL INFORM THE CONTRACTOR OF THE EXISTENCE AND LOCATION AND TAKEN ON HIS/HER OWN EXPENSE THE FACILITIES IN SERVICE AND TO PROTECT THEM FROM DAMAGE DURING CONSTRUCTION AND MAINTENANCE. EXISTING FACILITIES TO BE MAINTAINED THAT ARE DAMAGED BECAUSE OF NON-COMPLIANCE WITH THIS PROVISION SHALL BE REPLACED AT THE CONTRACTOR'S OWN EXPENSE.
9. THE CONTRACTOR SHALL PROVIDE TEMPORARY TOILET FACILITIES AND HAND SANITIZING STATIONS FOR THE USE OF ALL THE CONTRACTOR'S PERSONNEL EMPLOYED ON THE WORK SITE. THE FACILITIES SHALL BE MAINTAINED IN A SANITARY CONDITION THROUGHOUT THE PROJECT. THE LOCATION OF THE TEMPORARY FACILITIES SHALL BE APPROVED BY THE ENGINEER.
10. THE CONTRACTOR IS RESPONSIBLE FOR COMPLYING WITH THE NPDES PERMIT AND SMPPP MANUAL. IF NO NPDES PERMIT OR SMPPP MANUAL IS NEEDED FOR THE PROJECT, THE CONTRACTOR SHALL PERFORM SOIL CONTAMINATION CONTROL, BEST PRACTICES OR AS DIRECTED BY THE OWNER TO PREVENT ILLEGAL DISCHARGES FROM THE SITE.

## UTILITY NOTES

1. UNDERGROUND WORK SHALL INCLUDE TRENCHING, DISPOSAL OF EXCESS MATERIAL, Dewatering, INSTALLATION OF PIPE, CASTINGS, STRUCTURES, BACKFILLING OF TRENCHES AND COMPACTION, and TESTING AS SHOWN ON THE CONSTRUCTION PLANS. FITTINGS AND ACCESSORIES NECESSARY TO COMPLETE THE WORK MAY NOT BE SPECIFIED, BUT SHALL BE CONSIDERED AS INCLUDED TO THE COST OF THE CONTRACT. ALL SEWER SHALL BE INSTALLED USING A LASER AND BEAT AT THE DOWNTREAM END.
2. SANITARY SERVICE CONNECTIONS TO NEW SEWERS SHALL BE MADE WITH WYE BRANCHES. WYE BRANCHES SHALL BE FACTORY MANUFACTURED PERMANENTLY AFFIXED TO THE MAIN SEWER. TEE BRANCHES ARE NOT ALLOWED.
3. ALL CONNECTIONS TO EXISTING OR DISSIMILAR STORM/SANITARY LINES SHALL BE DONE WITH STAINLESS STEEL NON-SHEAR COUPLINGS.
4. STONE BEDDING AND BACKFILL SHALL BE OMITTED FOR A DISTANCE OF 15 FEET UP AND DOWNTREAM OF THE POINT OF INLET FROM PONDS OR STREAMS. THE REPLACED BEDDING SHALL BE SILTY CLAY SOIL MECHANICALLY COMPACTED TO 80% MODIFIED PROCTOR DENSITY. THE USE OF PERMEABLE SOILS WILL NOT BE PERMITTED.
5. ALL WATER MAIN SHALL HAVE MECHANICAL RESTRAINED TYPE JOINTS AT ALL CONNECTIONS AND FITTINGS. IN ADDITION, ALL HARDWARE SHALL BE STAINLESS STEEL.
6. THRUST BLOCKING SHALL BE PROVIDED ON WATER MAIN AT ALL BENDS, TEES, ELBOWS, ETC. INDIVIDUAL INSPECTION FOR ALL THRUST BLOCKING IS REQUIRED. THRUST BLOCKING SHALL BE Poured IN PLACE CONCRETE. PRECAST BLOCKS MAY BE USED AS APPROVED BY THE ENGINEER IN THE FIELD.
7. ALL FLOOR DRAINS SHALL DISCHARGE TO THE SANITARY SEWER. ALL DOWNSPOUTS, SIDE YARD DRAINS, AND OUTSIDE DRAINS SHALL DISCHARGE TO THE STORM SEWER SYSTEM. FOOTING DRAINS SHALL FIRST DRAIN TO A SUMP PIT.

NON-WOVEN	STYLE DESCRIPTION	STANDARDS/REQUIREMENTS	RECOMMENDED PRODUCTS
MEDIUM DUTY	UNDERGARMENT FABRIC	<p><b>5 MIL</b></p> <p><b>MINIMUM GRADIENT TENSILE ASTM D4534 = 150 LB/S</b></p> <p><b>MINIMUM TENSILE STRENGTH AT 5% STRAIN = 100 LB/S</b></p> <p><b>MINIMUM FLOW RATE ASTM D4646 = 110 CAL/CM<sup>2</sup>/INFT</b></p>	<p><b>PROSPER 200EX 901</b></p> <p><b>5 MIL FABRIC TESTER</b></p> <p><b>THREAC LIQ 150EX</b></p> <p><b>TEMATE LIQUIF 100EX</b></p>



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## GENERAL NOTES

POPEYES LOUISIANA KITCHEN  
1815 NORTH MAIN STREET  
WHEATON, ILLINOIS

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#### EROSION CONTROL NOTES

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**EROSION CONTROL NOTES**

1. AT A MINIMUM, THE CONTRACTOR SHALL INSTALL AND MAINTAIN SOIL EROSION AND SEDIMENT CONTROL BEST MANAGEMENT PRACTICES IN ACCORDANCE WITH THE REQUIREMENTS SET FORTH IN THE LATEST EDITION OF THE ILLINOIS ENVIRONMENTAL PROTECTION AGENCY'S URBAN MANUAL.
2. DISTURBED AREAS AND AREAS USED FOR STORAGE OF MATERIALS THAT ARE EXPOSED TO HEAVY RAINFALL OR FLOODING EVENTS, OR, ON THE POTENTIAL FOR POLLUTANTS ENTERING THE DRAINAGE SYSTEM, WHERE DISCHARGE POINTS OR POINTS ARE ACCESSIBLE, SHALL BE INSPECTED TO ASCERTAIN WHETHER EROSION CONTROL MEASURES ARE EFFECTIVE IN PREVENTING SIGNIFICANT IMPACTS TO RECEIVING WATERS.
3. LOCATIONS WHERE VEHICLES ENTER OR EXIT THE SITE SHALL BE INSPECTED FOR EVIDENCE OF OFF-SITE SEDIMENT TRACKING. THE CONTRACTOR SHALL BE RESPONSIBLE FOR CLEANING ANY ROAD OR OTHER SURFACE WHERE POLLUTANT SPILLS OCCUR. THIS SHALL BE DONE AT THE CLOSE OF EACH DAY OF WORK OR MORE FREQUENTLY AS FIELD CONDITIONS WARRANT.
4. ALL STORM WATER STRUCTURES WITH OPEN LIDS SHALL BE PROTECTED WITH INLET FILTER BASKETS. DURING CONSTRUCTION, SEDIMENT SHALL BE REMOVED AS NEEDED, AND BASKETS SHALL BE REPAIRED OR REPLACED AS NEEDED.
5. AFTER ACHIEVING PERMANENT VEGETATION, ALL EROSION AND SEDIMENT CONTROL DEVICES SHALL BE REMOVED, AND THE DRAINAGE STRUCTURES SHALL BE CLEANED.
6. THE CONTRACTOR SHALL KEEP A WATER SOURCE AT THEIR DISPOSAL FOR THE PURPOSE OF WATERING DOWN SOIL ON SITE AND ADJACENT ROADWAYS WHICH OTHERWISE MAY BECOME AIRBORNE DUST.
7. THE CONTRACTOR SHALL STABILIZE ALL IDLE, DISTURBED AREAS WITHIN SEVEN DAYS OF CESSION OF THE CONSTRUCTION ACTIVITIES IN THAT AREA.
8. THE CONTRACTOR IS EXPRESSLY ADVISED NOT TO DISTURB AREAS WHICH ARE OUTSIDE THOSE NECESSARY TO PROVIDE THE IMPROVEMENTS AS CALLED FOR IN THE PLANS.
9. ALL EROSION CONTROL MEASURES SHALL BE REPLACED IF DAMAGED OR MAINTAINED THROUGHOUT THE LIFE OF THE PROJECT.
10. ALL BYPASS CHANNELS, MUST BE CONSTRUCTED SO THAT CHANNEL FLOWS WILL NOT CAUSE EROSION OF EXCAVATED MATERIAL. IN EACH CASE A SEDIMENTATION BASIN MUST BE CONSTRUCTED SO AS TO ALLOW THE SEDIMENT TO SETTLE PRIOR TO THE DOWNSTREAM OUTLET OF THE PROJECT AREA.
11. PUMPS MAY BE USED AS BYPASS DEVICES, BUT IN NO CASE WILL THE WATER BE DIVERTED OUTSIDE THE PROJECT LIMIT. ALL PUMPED WATER SHALL BE FREE OF SILT. PUMPING MAY REQUIRE THE USE OF A SEDIMENT CONTAINMENT FILTER BAG AND OTHER SUPPLEMENTAL SEDIMENT CONTROL MEASURES.
12. CONCRETE WASHDOWN FACILITIES SHALL BE MADE AVAILABLE IF NEEDED, AND PROPERLY MAINTAINED THROUGHOUT THE PROJECT.
13. PROPERLY MANAGE ALL MATERIAL STORAGE AREAS, PORTABLE TOILETS, AND EQUIPMENT FUELING, CLEANING, AND MAINTENANCE AREAS TO ENSURE THESE AREAS ARE FREE OF SPILLS, LEAKS, OR OTHER POTENTIAL POLLUTANTS.
14. WASTE, CONSTRUCTION DEBRIS, AND BUILDING MATERIALS SHALL BE COLLECTED AND PLACED IN APPROVED RECEPACLES.


STORM SEWERS	MODEL/DESCRIPTION	STANDARD REQUIREMENTS	OPTIONAL REQUIREMENTS
	PSW 520-26	PC-ASTM D-2321	JOINT ASTM D-2312
	RPC CLIV	PC-ASTM D-275	JOINT D-2312
FRAME & GATE/UD	PAVED AREAS	OPEN UD N/A	CLOSED UD NEENAH R-1772 (200 LBS)
	CURB STRUCTURES	OPEN UD NEENAH R-2318 1/4" WOPEN CURB BOX	CLOSED UD N/A
	GRASS AREAS	OPEN UD N/A	CLOSED UD NEENAH R-1772
ADJUSTMENT RINGS	CONCRETE	4" MINIMUM, 12" MAXIMUM	
PIPE BEDDING MATERIAL	CA-1		
PIPE HORN BACKFILL	CA-8		

WATER MAIN	MODEL/SPECIFICATION	STANDARDS/REQUIREMENTS
WATER BOXES	5' x 22' TWO PIECE SCREWED 1/4" DRILLED 1/2" NPT WATER VALVE BOX ADAPTER # BVB ADAPTOR INC.) REQUIRED FOR STABILIZATION (SEE CITY OF WHEATON DETAILS ON SHEET 11)	
WATER VALVES	ANWVA C-509	RESILIENT WEDGE GATE VALVE
WATER MAIN FITTINGS	ANWVA C-153	ALL FITTINGS MUST BE MANUFACTURED IN THE USA
PIPE BEADING MATERIAL	CA-11	
TRENCH BACKFILL	CA-8	
POLYWRAP	B MIL BLACK POLY	WRAP ANISHAWWA C10A/21.5
CURB STOP	NO LEAD BRASS	MUELLER B-2514, FORD 02-444 MAY HAVE COMPRESSION OR FLARE JOINTS, MINNEAPOLIS PATTERN
CURB BOX		MUELLER H1000
CORPORATION VALVE	NO LEAD BRASS	MUELLER H-15000, FORD 600
SERVICE SPOUT	DOUBLE STRAP SADDLE WATER SERVICE PIPE	MUELLER SS SERIES 55 DULE STRAP, FORD FS323, ROMAC 308 TYPE A COPPER PIPE/ASTM B-88
SANITARY SEWERS	MODEL/SPECIFICATION	STANDARDS/REQUIREMENTS

WATER MAIN CLASS	PVC SDR 26	PIPE ASTM D-2241 CLOSED UD NEENAH R-1772 (200 LBS)	JOINT ASTM D-3105 GASKET ASTM F-47 LIDS STAMPED "SANITARY MANHOLE"
FRAME & GATEAU	PAVED AREAS	4" X 100' 1000 LB. TEST (325 LBS)	
ADJUSTMENT RINGS	CONCRETE	4" X 100' 1000 LB. TEST (325 LBS)	
PIPE BEDDING MATERIAL	CA-11		
PIPE COATING	CA-11		
CHIMNEY SEAL	CHI-TEX	ASTM C-622	
MANHOLE CONNECTIONS		ASTM C-622	
JOINT WRAP	MAC WRAP	ASTM C-877 TYPE II	


TESTING REQUIREMENTS	TESTING DETAILS
WATER MAIN	ALL WATER MAIN SHALL HAVE A PRESSURE AND LEAKAGE TEST PERFORMED IN ACCORDANCE WITH SECTION 41-2.14 OF STANDARD SPECIFICATIONS FOR WATER AND SEWER CONSTRUCTION IN ILLINOIS ACCEPT THE PRESSURE DURING THE TESTS SHALL BE EQUAL TD 150PSI
SANITARY SEWER	ALL SANITARY SEWER SHALL BE TESTED IN ACCORDANCE WITH THE STANDARD SPECIFICATIONS FOR WATER AND SEWER CONSTRUCTION IN ILLINOIS. ALL PROBABLE LEAKS SHALL BE LOCATED AND TESTED BY THE B OR C TEST METHODS AS OUTLINED IN SECTION 31-1.12. ALL FLEXIBLE SANITARY SEWER PIPE SHALL BE TESTED BY METHOD B OR C TEST METHODS. ALL B OR C. ALL SANITARY SEWER MUST BE TESTED BY METHOD E. THE CONTRACTOR SHALL PROVIDE THE TESTER WITH A PORTABLE VIDEO OR A DIGITAL VIDEO DISC. THE VIDEO MUST BE IN COLOR AND PRODCE NO FASTER THAN 1 FOOT PER SECOND.
SEWER WATER MAIN CROSSINGS	ALL SEWERS THAT CROSS OR RUN PARALLEL TO WATER MAINS SUBJECT TO EPA REQUIREMENTS FOR WATER MAIN PIPE. PIPE MUST BE PRESSURE TESTED ACCORDING TO 41-2.14 OF THE STANDARD SPECIFICATIONS FOR WATER AND SEWER CONSTRUCTION IN ILLINOIS.
SANITARY MANHOLES	ALL SANITARY MANHOLES SHALL BE TESTED BY EITHER ASME C.060 OR ASTM C-1744

FILE 5828.000-Popeyes Wheaton-DT.dwg		SHEET NUMBER
DRAWN BY: TLM	GHA PROJECT #	<b>12</b>
DATE 12-20-24	5828.000	
CHEKED BY: AJP	SCALE	of 19 SHEETS
DATE 12-20-24	N.A.	

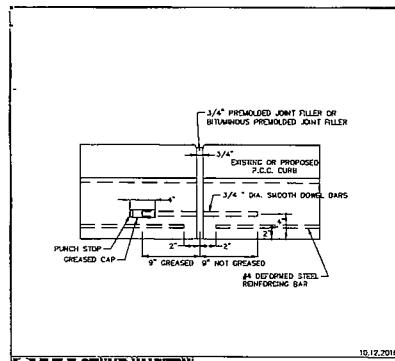


**GHA GERALD HAMILTON  
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NOTE:  
PROPOSED PCC PAVEMENT SHALL BE 6" THICK IN PUBLIC RIGHT OF WAY AND 5" THICK EVERYWHERE ELSE.

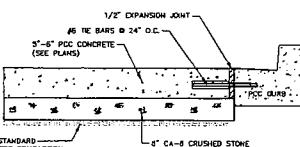

**GHA** GENALT HAMILTON  
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**DETAILS**


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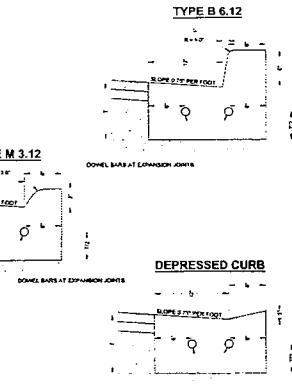
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**DETAILS**

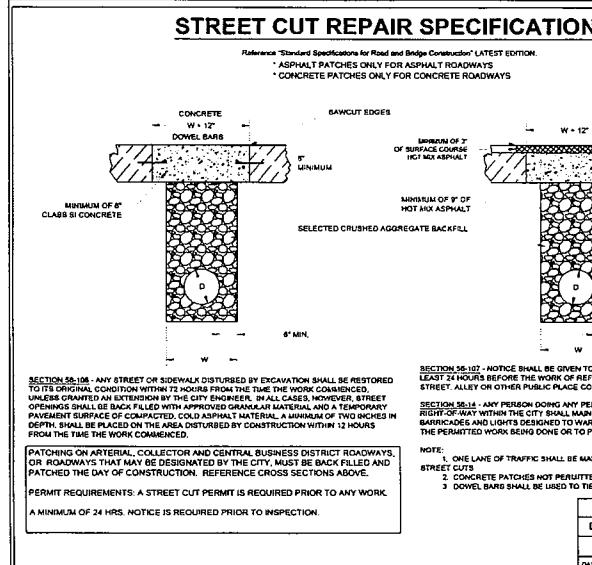
**POPEYES LOUISIANA KITCHEN**  
**1815 NORTH MAIN STREET**  
**WHEATON, ILLINOIS**



**CURB & GUTTER SPECIFICATIONS**

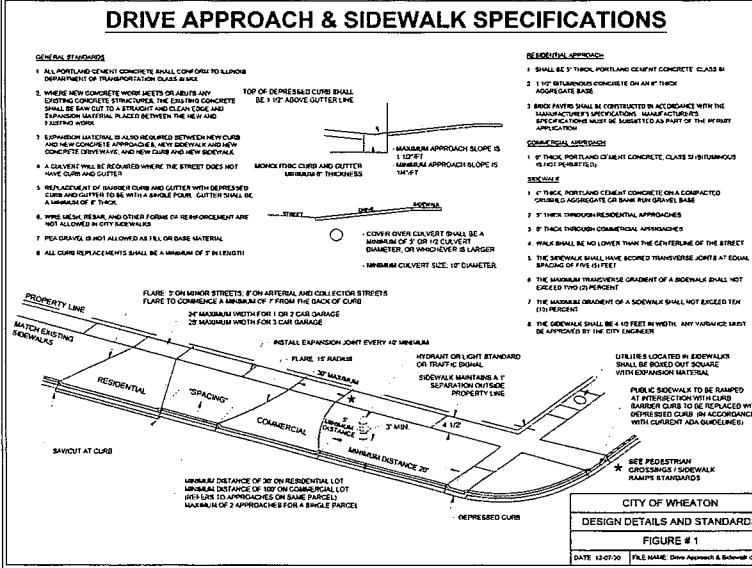

DOVETAIL AND EXPANSION JOINTS		T - THICKNESS OF PAVEMENT
NOTES		
1	TWO HDG & STEEL DOWEL BARS WITH CAPS TO BE USED AT ALL EXPANSION JOINTS	1/2"
2	CONSTRUCTION JOINTS ARE 12" IN INTERVALS	
3	INSTALL THREE 3' REBAR AT ALL TRENCH CROISSEMENT. BARS TO EXTEND 2 FT BEYOND EDGE OF TRENCH AND HAVE A MINIMUM LENGTH OF 10 FT	
4	THE CROWN OF THE ROAD WILL BE A DEPTH SUFFICIENT TO BRING THE CURB AND GUTTER TO THE SAME LEVEL	
5	THE BASE COURSE LOCATED UNDER THE CURB AND GUTTER WILL NOT BE FOR CONCRETE, BUT FOR A DENSE GRAVEL BASE COURSE, 4" THICK, FOR CONCRETE CURB AND GUTTER OF THE TYPE SPECIFIED	
CITY OF WHEATON		
DESIGN DETAILS AND STANDARDS		
FIGURE # 4		
DATE: 10/28/02 BY: [Signature]		

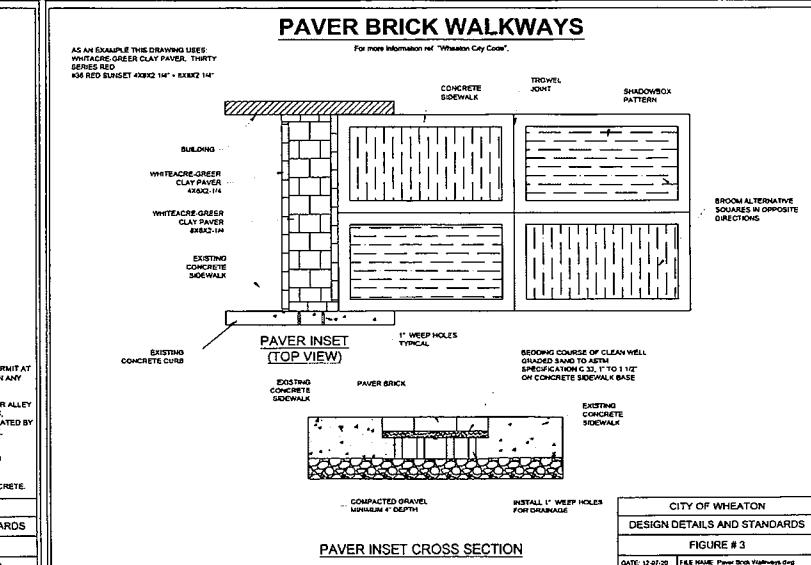



**PAVER INSET CROSS SECTION** **FIGURE #3**

**CITY OF WHEATON**  
**DESIGN DETAILS AND STANDARDS**  
**FIGURE # 3**

SHEET NUMBER:  
**13**  
OF 19 SHEETS





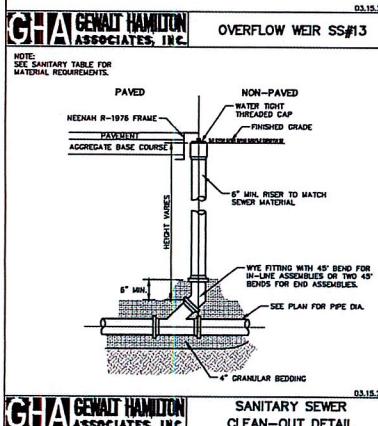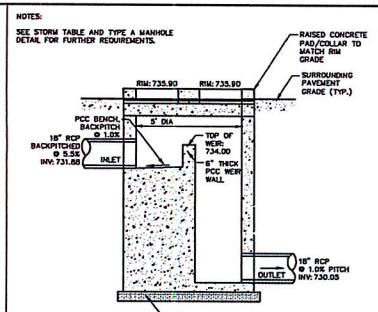

**WaGate Flap Valve**  
**KVI NPS 8"-24"**


**Use**  
Used as flood protection and emergency shutdown  
For mounting on outlet pipes in ducting or from

- Pipe Insert with 2 rubber rings for sealing against existing piping
- Can be mounted below the water surface
- The flap has a 15 degree inclination
- Corrosion-proof materials
- UV-resistant


**Material**  
Valve pipe: PE 100  
Flap: PEHD 500 UV-beständig  
Hinges: EP 400/3-3+15 LD rubber  
Seal against flap: EPDM  
Steel: EN 14404

**Technical data**  
Waterproof for one-sided  
pressure  
Max pressure: 0.5 psi  
Temperature: -50°C - 50°C

Dimensions [in] and weight [lbs]									
W	L	H	W	L	H	W	L	H	W
8	8	71-79	164	65	79	15.5	20.9	10.7	9
9	9	81-89	184	72	79	15.8	22.1	11.6	10.6
10	10	91-99	205	81	91	16.5	25.6	12.8	13.4
11	11	98-111	230	91	99	19.5	26.4	14	16.5
12	12	112-124	258	102	118	19.7	28.9	15.9	24
14	14	126-144	291	115	118	24.8	30.5	17.6	33.5
16	16	141-158	327	129	15.8	28.7	37	19.7	41
18	18	159-177	368	14.5	177	31.5	42.5	22.8	45.9
20	20	178-197	409	161	197	35.4	46.3	23.1	52.6
22	22	198-222	458	173	211	38.6	51.2	27.3	57.2
24	24	223-248	506	203	236	40.1	57.5	30.1	61.6

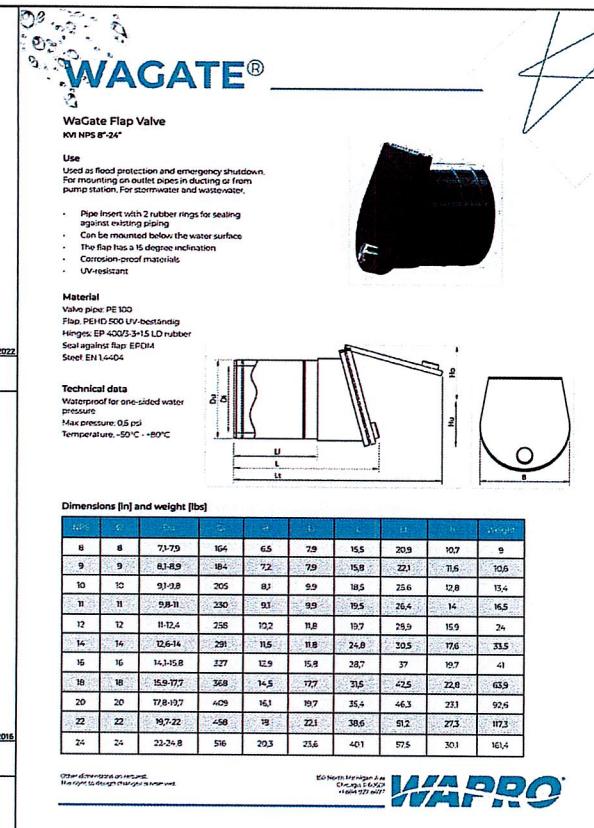

## **TYPICAL INSTALLATION STORM SEWER RESTRICTOR**

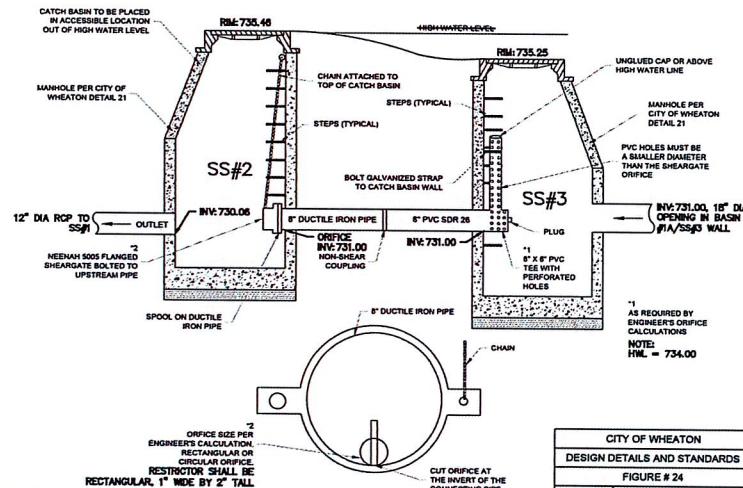


<b>CITY OF WHEATON</b>	
<b>DESIGN DETAILS AND STANDARDS</b>	
<b>FIGURE # 24</b>	

## **SANITARY MANHOLE**

**NOTES:**

3. All frames and lids must have concealed pick holes and gasketed seal-venting features. ("O" ring seals are not permitted. Flat gaskets must be required, and frame must accommodate chimney seal).
3. All lids must be stamped "Sanitary Manhole".
4. Manholes must have one piece integral base and barrel section.
5. Manholes must be 4" diameter for sewers 18" or less, and 5" diameter for sewers larger than 18" and less than 48".
6. Manholes 4" in diameter which exceed a depth of 4' shall have steps that are 18" wide and 14" high, made of flexible polypropylene plastic. "Step" type instillation. Steps shall be 18" apart on center.
7. All Manholes must have chimney seal collars.
8. All joints between barrel sections shall be sealed with flexible butyl mastics. Joints up to 1/2" wide by 1/2" thick. All joints between ring frames and to be sealed with flexible butyl mastic material 2 1/2" wide by 1/2" thick.
9. External or internal chimney seals must be installed between the dome and frame.
10. All connections to be by pre-tensioned synthetic rubber sleeve with stainless steel clamps, non-tree-type.
11. When shimming to grade is required in paired areas, threaded rubber adjustment rings and bushy mastic shall be used. No shimming of any kind or monstar layers are allowed.
12. The maximum amount of adjustment for frame elevation is 8" with 2" setbacks. Concrete adjusting rings shall have a minimum thickness of 2". Rubber adjustment rings shall have a minimum thickness of 3". Setbacks must be used in cases where a difference in elevation is greater than 8". Monstar layers are not allowed and bricks shall not be used for shimming the frame on the structure.
14. When an accessible frame is used:
  - A. If the Manhole is 3' or less, then the cover shall be 18" x 24" in height.
  - B. If the Manhole is 3' of less, then the cover shall be 23 1/2" x 33" in height.

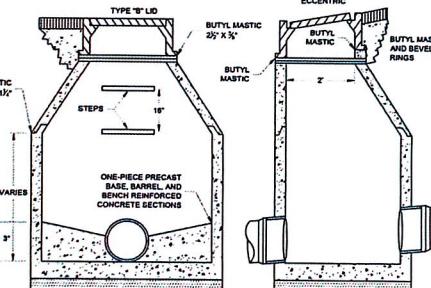

**CITY OF WHEATON**  
**DESIGN DETAILS AND STANDARDS**  
**FIGURE # 16**

E 5828.000-Popeyes Whirlton-DT.dwg		SHEET NUMBER	
AWN BY: TLM	GHA PROJECT #	16	
ITE 12-20-24	5828.000		
ECED BY: AJP	SCALE	OF 19 SHEETS	
ITE 12-20-24	N.A.		

