

**ORDINANCE NO. O-2025-14**

**AN ORDINANCE GRANTING A SPECIAL USE PERMIT TO ALLOW THE CONSTRUCTION AND USE OF A 1,580 SQUARE FOOT COMMERCIAL BUILDING FOR A FAST FOOD AND DRIVE-THROUGH RESTAURANT, ON A CERTAIN PIECE OF PROPERTY COMMONLY KNOWN AS 1815 N. MAIN STREET - POPEYES**

**WHEREAS**, written application has been made requesting a special use permit pursuant to Article 18.3 of the Wheaton Zoning Ordinance to allow the construction and use of a 1,580 square foot commercial building for a fast food and drive-through restaurant, all on certain property legally described herein and commonly known as 1815 N. Main Street, Wheaton, Illinois 60187; and

**WHEREAS**, pursuant to notice as required by the Illinois Municipal Code and the Wheaton Zoning Ordinance, a public hearing was conducted by the Wheaton Planning and Zoning Board on February 25, 2025 and March 11, 2025, to consider the special use permit; and the Planning and Zoning Board has recommended approval of the special use permit.

**NOW, THEREFORE, BE IT ORDAINED** by the Mayor and City Council of the City of Wheaton, DuPage County, Illinois, pursuant to its home rule powers, as follows:

**Section 1:** The following described property has been and continues to be zoned and classified in the C-3 General Commercial District zoning classification:

LOT 2 IN BLOCK 4 IN ARTHUR T. MCINTOSH AND COMPANY'S GENEVA ROAD SUBDIVISION, BEING A SUBDIVISION IN THE NORTHWEST QUARTER OF SECTION 9, TOWNSHIP 39 NORTH, RANGE 10 EAST OF THE THIRD PRINCIPAL MERIDIAN, ACCORDING TO THE PLAT THEREOF RECORDED JUNE 26, 1924 AS DOCUMENT 179449 AND CERTIFICATE OF CORRECTION FILED AUGUST 15, 1924 AS DOCUMENT 180974, IN DUPAGE COUNTY, ILLINOIS.

P.I.N.: 05-09-108-002

The subject property is commonly known as 1815 N. Main Street, Wheaton, IL 60187.

**Section 2:** Pursuant to the Findings of Fact made and determined by the Wheaton Planning and Zoning Board, a special use permit pursuant to Article 18.3 of the Wheaton Zoning Ordinance is granted to allow the construction and use of a 1,580 square foot commercial building for a fast food and drive-through restaurant at 1815 N. Main Street, in full compliance with the following plans: "Site Plan and Signage", "Elevations and Trash Enclosure", and "Fence and Wall Details", prepared by Thomas V. Scesniak Associates, Schamburg, IL, dated March 24, 2024 and revised March 6, 2025; "Site Plan - Popeyes Louisiana Kitchen, 1815 N. Main Street, Wheaton IL", prepared by Gewalt Hamilton Associates, Inc., Vernon Hills, IL, dated December 20, 2024 and revised March 4, 2025; and "Preliminary Engineering and Landscape Plans - Popeyes Louisiana Kitchen, 1815 N. Main Street, Wheaton IL", prepared by Gewalt Hamilton Associates, Inc., Vernon Hills, IL, dated December 20, 2024, subject to the following conditions:

1. The photometrics plan shall be revised to meet code;
2. All floodplain and wetland permitting shall be authorized by DuPage County as the City of Wheaton is a partial waiver community;
3. The underground compensatory storage facility shall be constructed with proper foundations and structural engineering calculations to ensure that the proposed underground structure is



able to be built on these soils. All outside consultant review fees charged to the City in the review of such structural engineering calculations shall be charged to the applicant as a plan review fee; and

4. The preliminary engineering plan shall be subject to further staff review prior to the issuance of a site development permit.

**Section 3:** All ordinances or parts of ordinances in conflict with these provisions are repealed.

**Section 4:** This ordinance shall become effective from and after its passage, approval, and publication in pamphlet form in the manner prescribed by law.

  
Mayor

ATTEST:

  
City Clerk

**Roll Call Vote:**

Ayes: Councilman Weller  
Councilman Barbier  
Councilwoman Bray-Parker  
Councilman Brown  
Mayor Suess  
Councilman Clousing  
Councilwoman Robbins


Nays: None

Absent: None

Motion Carried Unanimously

Passed: April 7, 2025  
Published: April 8, 2025


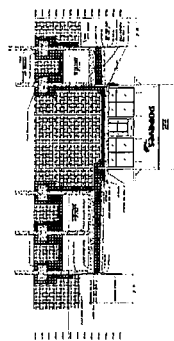


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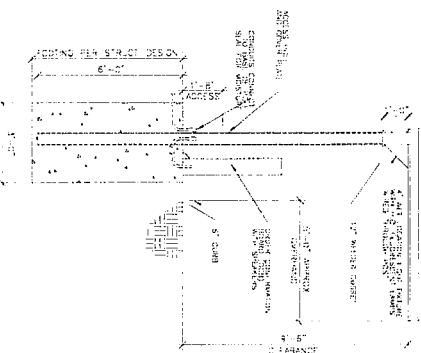
RENT LIAISON to S. HENRIEN 2nd

S. HENRIEN 2nd


S. HENRIEN 2nd

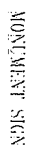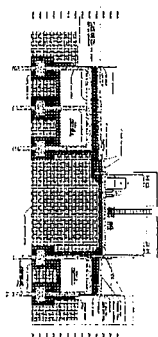

# SHAKEL CANOY



# СЛАВЯНСКЕ СЛОВ

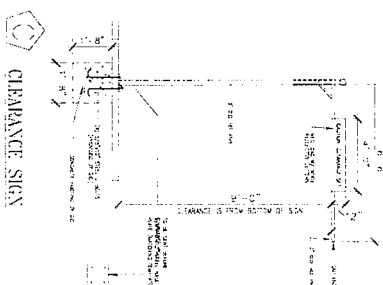

## PREVIEW BOARD



DIRECTIONAL SIGN



STX

## SITE PLAN & SIGNAGE



**THOMAS V. SCEŚNIAK associates**  
75 West Alameda, Suite 200, San Francisco, CA 94103  
Tel: 415.398.1170 Fax: 415.398.1171 E-mail: [tscesniak@att.net](mailto:tscesniak@att.net)  
Web: [www.tscesniak.com](http://www.tscesniak.com)






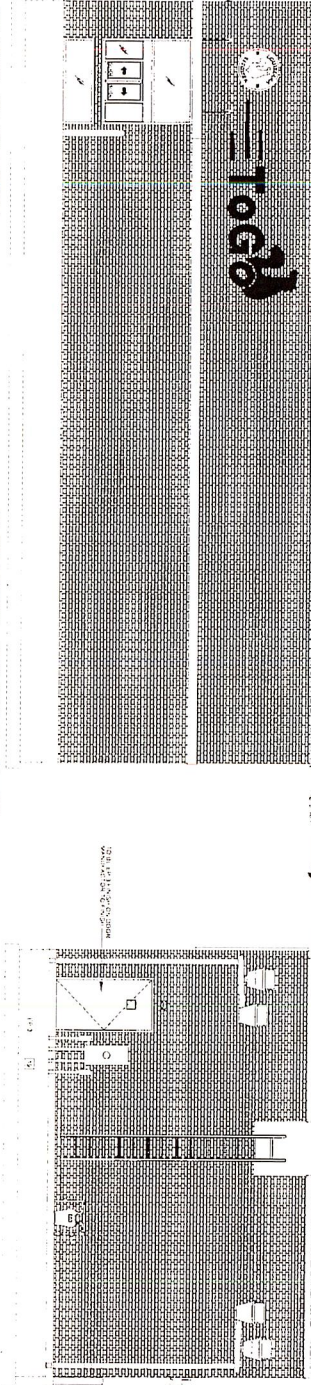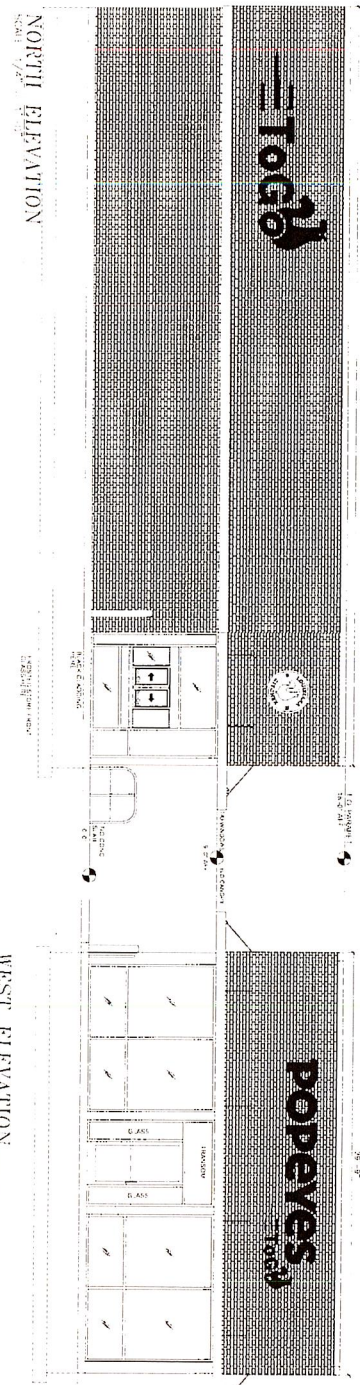

SOUTH ELEVATION  
SCALE 1/8" = 1'-0"

ELEVATION GENERAL NOTES

EAST ELEVATION  
SCALE 1/8" = 1'-0"

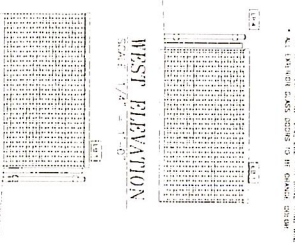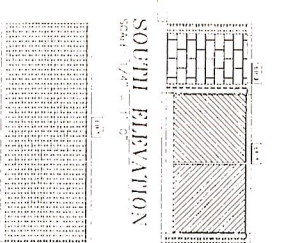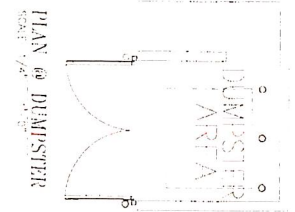

SOUTH ELEVATION  
SCALE 1/8" = 1'-0"

EAST ELEVATION  
SCALE 1/8" = 1'-0"

PLAN OF DINING ROOM  
SCALE 1/8" = 1'-0"

ROBERT'S CUISINA KITCHEN-EQUIPMENT SCHEDULE

ITEM	DESCRIPTION	QUANTITY	UNIT	PRICE	TOTAL
1-1	STOVE	1	EA	1,200.00	1,200.00
1-2	OVEN	1	EA	1,200.00	1,200.00
1-3	REF	1	EA	1,200.00	1,200.00
1-4	DISHWASHER	1	EA	1,200.00	1,200.00
1-5	SINK	1	EA	1,200.00	1,200.00
1-6	STOVE	1	EA	1,200.00	1,200.00
1-7	OVEN	1	EA	1,200.00	1,200.00
1-8	REF	1	EA	1,200.00	1,200.00
1-9	DISHWASHER	1	EA	1,200.00	1,200.00
1-10	SINK	1	EA	1,200.00	1,200.00
1-11	STOVE	1	EA	1,200.00	1,200.00
1-12	OVEN	1	EA	1,200.00	1,200.00
1-13	REF	1	EA	1,200.00	1,200.00
1-14	DISHWASHER	1	EA	1,200.00	1,200.00
1-15	SINK	1	EA	1,200.00	1,200.00
1-16	STOVE	1	EA	1,200.00	1,200.00
1-17	OVEN	1	EA	1,200.00	1,200.00
1-18	REF	1	EA	1,200.00	1,200.00
1-19	DISHWASHER	1	EA	1,200.00	1,200.00
1-20	SINK	1	EA	1,200.00	1,200.00

**KEYNOTES**

1. ALL WORK SHALL BE IN ACCORDANCE WITH THE LATEST EDITIONS OF THE BUILDING CODES AND SPECIFICATIONS.
2. ALL MATERIALS AND WORKMANSHIP SHALL BE SUBJECT TO INSPECTION AND APPROVAL BY THE CITY ENGINEER.
3. THE CONTRACTOR SHALL BE RESPONSIBLE FOR OBTAINING ALL NECESSARY PERMITS AND LICENSES.
4. THE CONTRACTOR SHALL MAINTAIN ACCESS TO ALL ADJACENT PROPERTIES AT ALL TIMES.
5. THE CONTRACTOR SHALL BE RESPONSIBLE FOR PROTECTING ALL EXISTING UTILITIES AND STRUCTURES.
6. THE CONTRACTOR SHALL MAINTAIN ADEQUATE SAFETY MEASURES THROUGHOUT THE PROJECT.
7. THE CONTRACTOR SHALL BE RESPONSIBLE FOR DISPOSING OF ALL DEBRIS AND WASTE MATERIALS.
8. THE CONTRACTOR SHALL MAINTAIN ADEQUATE RECORDS OF ALL WORK DONE.
9. THE CONTRACTOR SHALL BE RESPONSIBLE FOR OBTAINING ALL NECESSARY INSURANCE COVERAGE.
10. THE CONTRACTOR SHALL BE RESPONSIBLE FOR PAYING ALL TAXES AND FEES DUE.
11. THE CONTRACTOR SHALL BE RESPONSIBLE FOR OBTAINING ALL NECESSARY BONDS.
12. THE CONTRACTOR SHALL BE RESPONSIBLE FOR OBTAINING ALL NECESSARY REFERENCES.
13. THE CONTRACTOR SHALL BE RESPONSIBLE FOR OBTAINING ALL NECESSARY REFERENCES.
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19. THE CONTRACTOR SHALL BE RESPONSIBLE FOR OBTAINING ALL NECESSARY REFERENCES.
20. THE CONTRACTOR SHALL BE RESPONSIBLE FOR OBTAINING ALL NECESSARY REFERENCES.

**SYMBOL LEGEND**

1. ALL WORK SHALL BE IN ACCORDANCE WITH THE LATEST EDITIONS OF THE BUILDING CODES AND SPECIFICATIONS.



"CONCRETE" MANUFACTURED BRICK &  
STONE TO BE APPLIED TO PRECAST  
TUNNEL EXTERIOR WALL -----


Figure 1 shows a schematic diagram of a two-dimensional grid system. The grid is composed of horizontal and vertical lines. The horizontal axis is labeled 'A' and 'B' at the bottom, with 'A' on the left and 'B' on the right. The vertical axis is labeled 'C' and 'D' on the right, with 'C' on the left and 'D' on the right. The grid is divided into four quadrants by a central vertical line and a central horizontal line. The quadrants are labeled 'A-C', 'A-D', 'B-C', and 'B-D'.



[illegible][illegible]

- (A) POPPYE'S MONUMENT FOUNDATION SIGN. SEE ARCHITECTURAL PLANS
- (B) DIGITAL MENU BOARD - ELEVATED
- (C) DIGITAL PREVIEW BOARD - SPREAD FOUNDATION ON TOP OF PLANK
- (D) OVERSEER COMMUNICATION UNIT - ELEVATED
- (E) PICK UP WINDOW
- (F) CLEARANCE BAR - SPREAD FOUNDATION ON TOP OF PLANKS
- (G) ADA RAMP / LANDING
- (H) DUMPSTER ENCLOSURE FENCE
- (I) STOP SIGN
- (J) DOUBLE FACED SIGN, STOP / NO ENTRY
- (K) NO ENTRY SIGN
- (L) DRIVE-THRU ENTER HERE / ONE WAY SIGN
- (M) 24" STOP BAR, WHITE PAINT
- (N) DIRECTIONAL ARROWS, WHITE PAINT
- (O) "STOP" PASEMENT LETTERS, WHITE PAINT
- (P) WHEEL STOP (TYP.)
- (Q) 4" PARKING STALL LINE & 4" MOBIL LINE SPACED @ 2' O.C., YELLOW PAINT
- (R) 4" PARKING STALL LINE, YELLOW PAINT
- (S) 6" LANE LINE, WHITE PAINT
- (T) 6" WIDE CROSSWALK 1' WIDE BARS, 5' O.C., WHITE PAINT

	PCC PAVEMENT (ALL, HMA PAVEMENT)
	SALVAGED PAVERS
	PCC SIDEWALK
	STREET CUT REPAIR (SEE DETAILS)
	GRASS & TURF RESTORATION
	NATIVE VEGETATION PLANTINGS (SEE LANDSCAPE PLANS)
	BUILDING
	REP. RAP, CLASS RR-3
	DETECTABLE WARNINGS
	6" WIDE BARRIER CURB
	6" WIDE BARRIER CURB (DEPRESSED)
	INTEGRATED SIDEWALK/ 6" WIDE BARRIER CURB
	PROTECTIVE FENCE
	PAVEMENT SAWCUT
	PERIMETER EROSION BARRIER
	RETAINING WALLS

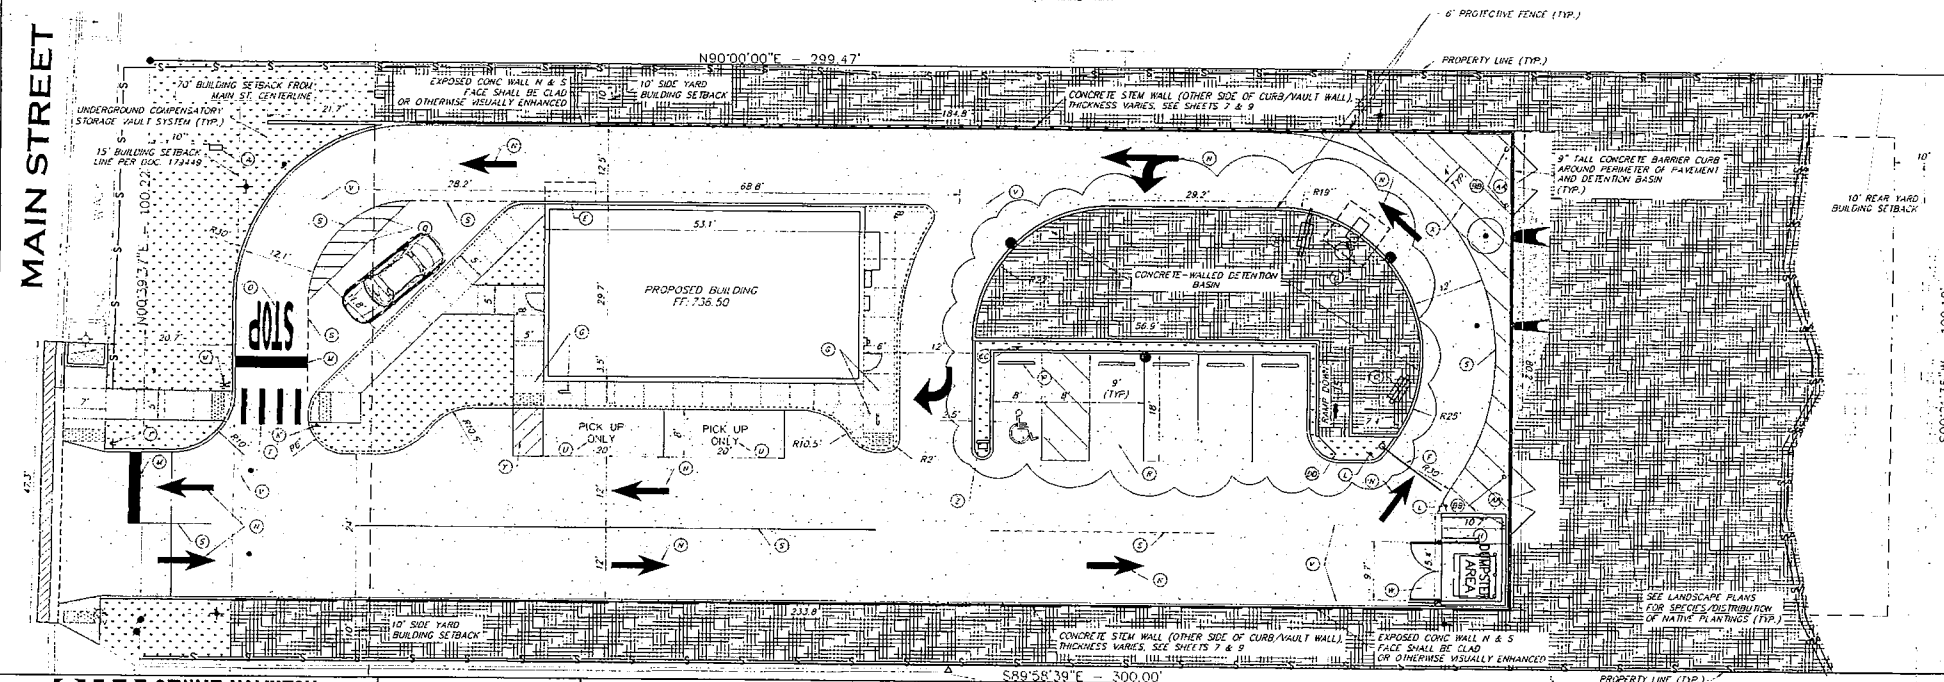

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POPEYES LOUISIANA KITCHEN  
1815 NORTH MAIN STREET  
WHEATON, ILLINOIS

1. NAME OF PROJECT: <u>NEW 24-HOUR POLICE STATION</u> 2. LOCATION: <u>1000 10th St. S.W.</u> 3. CITY: <u>ALBUQUERQUE, N.M.</u> 4. COUNTY: <u>BERNALILLO</u> 5. STATE: <u>N.M.</u> 6. ZIP: <u>87102</u> 7. PROJECT NO.: <u>1000</u> 8. DRAWING NO.: <u>1000</u> 9. DATE: <u>10/10/80</u> 10. BY: <u>1000</u> 11. DATE: <u>10/10/80</u> 12. REVISION: <u>1000</u>			13. TITLE: <u>NEW 24-HOUR POLICE STATION</u> 14. DRAWN BY: <u>1000</u> 15. DATE: <u>10/10/80</u> 16. CHECKED BY: <u>1000</u> 17. DATE: <u>10/10/80</u> 18. SCALE: <u>1/4" = 1'-0"</u> 19. SHEET NUMBER: <u>4</u> 20. OF 25 SHEETS		
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# CITY OF WHEATON

## POPEYES LOUISIANA KITCHEN

### 1815 NORTH MAIN STREET WHEATON, ILLINOIS

#### STANDARD SYMBOLS


FEATURE	EXISTING	PROPOSED
BUFFALO BOX		
BUSH/SHRUB		
CATCH BASIN		
CLEANOUT		
COMBINE SEWER LINE		
CONTOUR		
CULVERT		
DITCH/SWALE		
ELECTRIC LINE		
ELECTRIC MANHOLE		
FENCE		
FIRE HYDRANT		
FLARED END SECTION		
GAS LINE		
GAS MANHOLE		
GAS VALVE		
INLET		
LIGHT POLE		
OVERHEAD WIRES		
POWER POLE		
R.O.W LINE		
R.O.W MARKER		
SANITARY FORCEMAIN LINE		
SANITARY SEWER LINE		
SANITARY SEWER MANHOLE		
SIGN		
SPOT ELEVATION		
STORM SEWER LINE		
STORM SEWER MANHOLE		
TELEPHONE LINE		
TELEPHONE MANHOLE		
TELEPHONE BOX/PEDESTAL		
TREE-CONIFEROUS (SIZE/TAG#)		
TREE-DECIDUOUS (SIZE/TAG#)		
VALVE BOX		
VALVE VAULT		
WATER VALVE		
WATERMAIN LINE		

JULIE

JOINT  
UTILITY  
LOCATION  
INFORMATION FOR  
EXCAVATION  
CALL 811



Know what's below.  
Call before you dig.

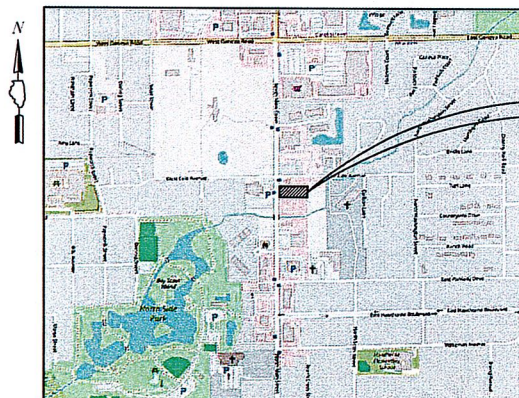

#### LOCATION MAP

(Not to Scale)

PROJECT LOCATION  
NORTH MAIN STREET  
WHEATON, ILLINOIS

TOPOGRAPHIC SURVEY BY:  
WEBSTER, MCGRATH & AHLBERG, LTD.  
207 SOUTH NAPERVILLE ROAD  
WHEATON, ILLINOIS 60187  
TELEPHONE: 630-868-7603

PLANS PREPARED FOR:  
R.A. SOLUTIONS, INC.  
1711 MAPLE AVENUE  
HANOVER PARK, ILLINOIS 60133  
TELEPHONE: 630-745-9226  
ATTN: MR. AKEEL RAMZANALI

#### COORDINATING/PERMITTING AGENCIES:

CITY OF WHEATON 1-630-280-2000  
DUPAGE COUNTY 1-630-407-8500  
US ARMY CORPS OF ENGINEERS 1-312-846-5530

SIGNED: DONALD E. DIXON P.E.  
DATE: DECEMBER XX, 2024  
ILLINOIS LICENSE NO.: 062-051136  
EXPIRATION DATE: NOVEMBER 30, 2025

#### CITY REVIEW SET

NOTE: CONSTRUCTION MEANS, METHODS AND JOB  
SITE SAFETY IS THE SOLE AND EXCLUSIVE  
RESPONSIBILITY OF THE CONTRACTOR

**GHA GEWALT HAMILTON**  
ASSOCIATES, INC.  
625 Forest Edge Drive ■ Vernon Hills, IL 60061  
Tel. 847.478.9700 ■ Fax 847.478.9701

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#### TITLE SHEET

POPEYES LOUISIANA KITCHEN  
1815 NORTH MAIN STREET  
WHEATON, ILLINOIS

FILE: 1828.000-Popeyes Wheaton-01.dwg	SHEET NUMBER
DRAWN BY: TJA DATE: 12-20-24	GHA PROJECT # 1828.000
CHECKED BY: ALP DATE: 12-20-24	SCALE N.A.
NO. BY DATE REVISION	NO. BY DATE REVISION
1	1
OF 19 SHEETS	





# EXISTING CONDITION AND DEMOLITION NOTES

1. PRIOR TO STARTING ANY CONSTRUCTION, PROVIDE SOIL EROSION AND SEDIMENT CONTROL DEVICES AS SHOWN ON THE PLANS AND AS REQUIRED PER IEPA NPDES GUIDELINES. REFER TO NOTES AND DETAILS THROUGHOUT THE ENTIRE PLAN SET.
2. CONTRACTOR SHALL REFER TO SUBSURFACE SOIL EXPLORATION REPORT.
3. NORTH MAIN STREET IS UNDER THE JURISDICTION OF THE CITY OF WHEATON. ALL WORK WITHIN THE RIGHT OF WAY WILL REQUIRE A PERMIT.
4. THE CONTRACTOR SHALL BE RESPONSIBLE FOR FENCING THE ACTIVE WORK ZONE FROM THE PUBLIC AND PROTECTING THE PUBLIC FROM ANY CONSTRUCTION RELATED HAZARDS. AT A MINIMUM, ALL EXCAVATION, DEMOLITION AREAS AND OTHER AREAS POTENTIALLY HAZARDOUS TO PEDESTRIANS AND VEHICLES MUST BE PROTECTED.
5. AT ALL TIMES, MAIN STREET SHALL REMAIN OPEN AND UNOBSTRUCTED. TEMPORARY SHUT DOWN OF ONE TRAFFIC LANE AT A TIME WILL BE PERMITTED FOR SHORT TERM PERIODS AND SHALL BE COORDINATED WITH APPOINTED PROPERTY OWNER CONSTRUCTION STAFF. SHORT TERM CLOSINGS SHALL BE COMPLETED WITHIN THE WORK DAY AND RESTORED TO UNOBSTRUCTED ACCESS BY THE CLOSE OF THE WORK DAY.
6. TEMPORARY STONE OR ASPHALT PATHWAYS SHALL BE PROVIDED AS NEEDED THROUGHOUT THE COURSE OF CONSTRUCTION TO FACILITATE SAFE PEDESTRIAN AND VEHICULAR MOVEMENT. THE LONGITUDINAL SLOPE OF SUCH PATHS SHALL NOT EXCEED 5% AND CROSS SLOPES SHALL NOT EXCEED 2%. PROVIDE 6" CA-6 BASE AND 2" SURFACE ASPHALT.
7. THE CONTRACTOR IS RESPONSIBLE FOR THE DEMOLITION AND DISPOSAL OF ALL EXISTING IMPROVEMENTS ON-SITE NECESSARY TO COMPLETE THE JOB. THESE IMPROVEMENTS INCLUDE, BUT ARE NOT LIMITED TO, EXISTING PAVEMENTS, CURBS, SIDEWALKS, FENCES, AND OTHER STRUCTURES WITHIN THE WORK AREA. EXCAVATE AND GRADE TO PROPOSED PAVEMENT AND BUILDING SUBBASE GRADES. (REFER TO FOUNDATION PLANS FOR PROPOSED BUILDING SUBBASE GRADES.) THESE ITEMS SHALL BE COMPLETELY REMOVED AND LEGALLY DISPOSED OF OFF-SITE. APPROVAL FROM THE PROJECT ENGINEER SHALL BE OBTAINED PRIOR TO REMOVING ANY EXISTING ITEMS NOT SHOWN OR MARKED FOR REMOVAL ON THIS SHEET.
8. REMOVE EXISTING UTILITIES AS SHOWN. UTILITIES THAT ARE REMOVED, UNLESS OTHERWISE NOTED, SHALL BE BACKFILLED WITH CA-6 CRUSHED STONE IN LIFTS OF 8" OR LESS AND COMPACTED TO 95% MODIFIED PROCTOR DENSITY.
9. THE CONTRACTOR SHALL INCLUDE ALL ASSOCIATED COSTS WITH THE REMOVAL, TRANSPORT, DISPOSAL, TESTING AND CERTIFICATION OF "UNCONTAMINATED SOIL" AS DEFINED UNDER 415 ILCS 5/3-180 INCLUDING ANY FEES, TAXES, OR SURCHARGES CHARGED BY OR THROUGH THE OPERATOR(S) OF CLEAN CONSTRUCTION OR DEMOLITION DEBRIS FILL OPERATIONS OR UNCONTAMINATED SOIL FILL OPERATIONS FOR THE ACCEPTANCE OF UNCONTAMINATED SOIL.

10. ALL VEGETATION AND LANDSCAPED AREAS NOT SHOWN REMAINING SHALL BE REMOVED AND DISPOSED OF OFF-SITE PROPERLY. REFER TO LANDSCAPE PLANS FOR DETAILED INFORMATION ON PLANTING REMOVALS AND TRANSPLANTS.
11. THE CONTRACTOR SHALL SUBMIT TO THE OWNER AND / OR CITY A CONSTRUCTION STAGING AND FENCING PLAN. PEDESTRIAN ACCESS CONFORMING TO ADA STANDARDS SHALL BE MAINTAINED ON ALL ADA ROUTES IMPACTED BY CONSTRUCTION AT ALL TIMES.
12. CONTRACTOR TO STRIP EXISTING TOPSOIL AND STOCKPILE IN THE LOCATION SHOWN ON THE PLANS. PRIOR TO FINAL PLACEMENT OF TOPSOIL, THE TOPSOIL SHALL BE PULVERIZED ON-SITE.
13. EXISTING CONDITION SURVEY PROVIDED BY WEBSTER, MCGRATH & AHLBERG, LTD. DATED AUGUST 7<sup>TH</sup>, 2017.

## REMOVAL LEGEND

- ASPHALT PAVEMENT PATCH
- EARTH/GRAVEL REMOVAL
- SIDEWALK REMOVAL
- PAVER REMOVAL AND SALVAGE
- WETLANDS/WATERS OF THE U.S. IMPACT
- CLEARING AND GRUBBING
- PERIMETER EROSION BARRIER
- CURB/COMBINATION CURB AND GUTTER REMOVAL
- UTILITY TO BE REMOVED
- PAVEMENT SAWCUT
- B.F.E. LINE
- WETLANDS/MOSS BOUNDARY

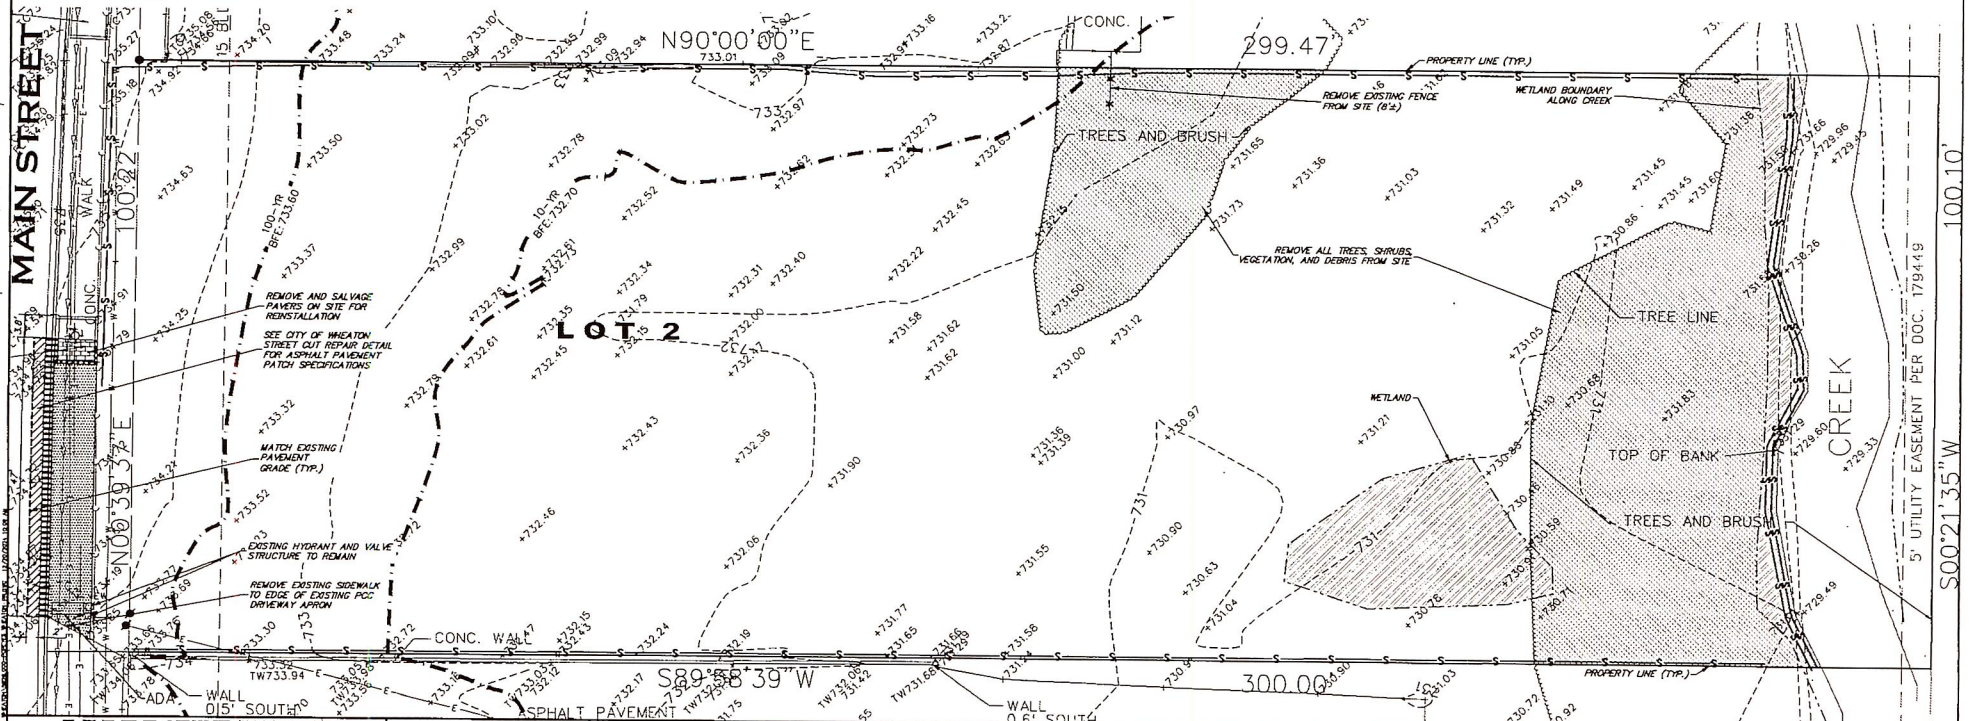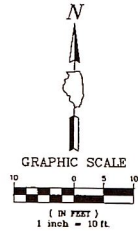

**GHA GEWALT HAMILTON ASSOCIATES, INC.**  
 625 Forest Edge Drive • Vernon Hills, IL 60061  
 Tel. 847.478.9700 • Fax 847.478.9701

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## EXISTING CONDITIONS/DEMOLITION PLAN

POPEYES LOUISIANA KITCHEN  
 1815 NORTH MAIN STREET  
 WHEATON, ILLINOIS

FILE: 5015.000-Popeyes Wheaton-PR.dwg	SHEET NUMBER:
DRAWN BY: TLM	GHA PROJECT #
DATE: 12-20-24	5828.000
CHECKED BY: AJP	SCALE:
DATE: 12-20-24	1" = 10'
NO. BY DATE	REVISION
NO. BY DATE	REVISION
NO. BY DATE	REVISION
NO. BY DATE	REVISION
NO. BY DATE	REVISION

2




OF 19 SHEETS



# UTILITY PLAN NOTES

- THE CONTRACTOR SHALL VERIFY THE EXACT LOCATION AND ELEVATION OF EXISTING UTILITIES PRIOR TO INITIATING WORK. ANY DISCREPANCIES FOUND BETWEEN THE INFORMATION NOTED ON THE PLANS AND ACTUAL FIELD CONDITIONS, OR ANY CONFLICTS WITH PROPOSED IMPROVEMENTS SHALL BE REPORTED TO THE ENGINEER IMMEDIATELY. THE CONTRACTOR SHALL NOT PROCEED ANY FURTHER UNTIL GIVEN WRITTEN CLARIFICATION ON HOW TO PROCEED.
- INSTALL STORM SEWER AS SHOWN. REFER TO STORM SEWER REQUIREMENT TABLE ON GENERAL NOTES SHEET FOR PIPE MATERIAL, JOINT, FRAME AND GRATE, STONE BEDDING AND TESTING REQUIREMENTS.
- INSTALL SANITARY SEWER AS SHOWN. REFER TO SANITARY SEWER REQUIREMENT TABLE ON GENERAL NOTES SHEET FOR PIPE MATERIAL, JOINT, FRAME AND GRATE, STONE BEDDING AND TESTING REQUIREMENTS.
- INSTALL WATERMAIN AS SHOWN. REFER TO WATER MAIN REQUIREMENT TABLE ON GENERAL NOTES SHEET FOR PIPE MATERIAL, JOINT, FRAME AND GRATE, VALVES, FIRE HYDRANT, STONE BEDDING AND TESTING REQUIREMENTS.
- CONTRACTOR SHALL PROVIDE THE FOLLOWING AS-CONSTRUCTED DOCUMENTS AT THE CONCLUSION OF THE PROJECT:
  - WATER MAIN
    - AS-CONSTRUCTED LOCATION OF ALL BENDS, TEES, VALVES, COPPER UNIONS, ETC. (MEASURED DIMENSION FROM TWO FIXED ABOVE GRADE OBJECTS ARE REQUIRED FOR BURIED OBJECTS)
    - RIM AND TOP OF PIPE ELEVATIONS FOR ALL STRUCTURES
    - PROVIDE ALL TESTING DOCUMENTATIONS.
  - SANITARY SEWER
    - AS-CONSTRUCTED LOCATIONS OF STRUCTURES, SERVICE CONNECTIONS, CLEANOUTS.
    - RIM AND INVERT ELEVATIONS.
    - COLOR VIDEO WITH TRANSCRIPT REQUIRED FOR NEW SEWER LINES INSTALLED.
  - STORM SEWER
    - AS-CONSTRUCTED LOCATIONS OF STRUCTURES, SERVICE CONNECTIONS, CLEANOUTS.
    - RIM AND INVERT ELEVATIONS.
- REFER TO MEP AND ARCHITECTURAL PLANS FOR ELECTRIC AND GAS REQUIREMENTS AND FINAL ROUTING.
- THE CONTRACTOR SHALL INCLUDE ALL ASSOCIATED COSTS WITH THE REMOVAL, TRANSPORT, DISPOSAL, TESTING AND CERTIFICATION OF "UNCONTAMINATED SOIL" AS DEFINED UNDER 415 ILCS 5/3.160 INCLUDING ANY FEES, TAXES, OR SURCHARGES CHARGED BY OR THROUGH THE OPERATOR(S) OF CLEAN CONSTRUCTION OR DEMOLITION DEBRIS FILL OPERATIONS OR UNCONTAMINATED SOIL FILL OPERATIONS FOR THE ACCEPTANCE OF UNCONTAMINATED SOIL.

## UTILITY PLAN LEGEND

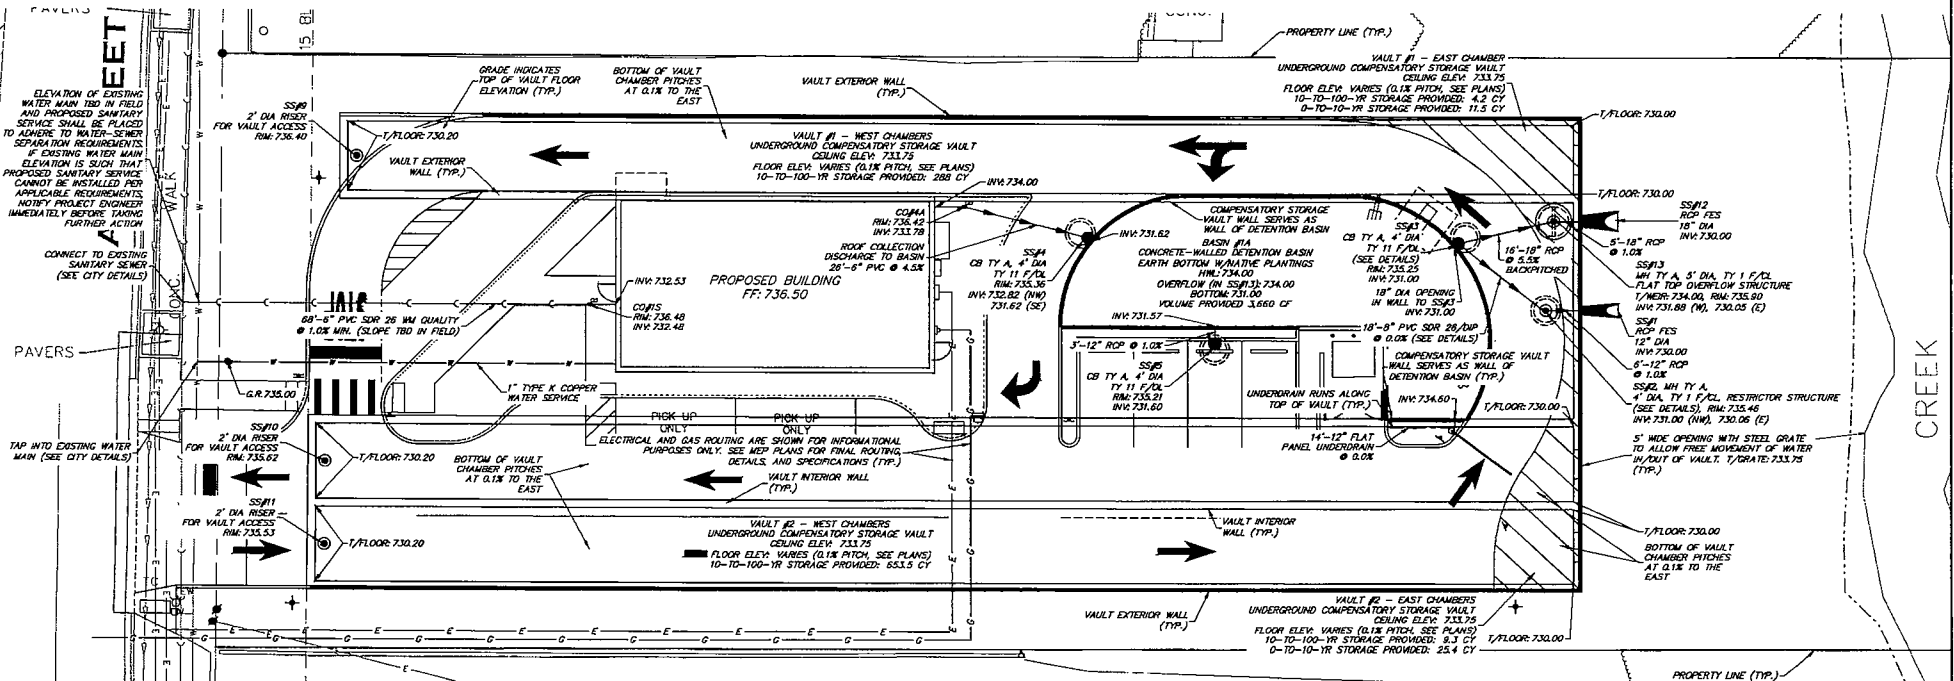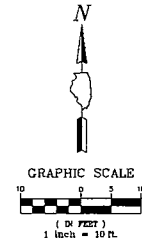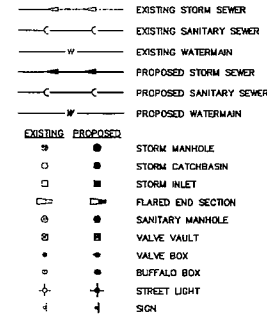

**GEWALT HAMILTON ASSOCIATES, INC.**  
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**UTILITY PLAN**  
POPEYES LOUISIANA KITCHEN  
1615 NORTH MAIN STREET  
WHEATON, ILLINOIS

NO.	BY	DATE	REVISION	NO.	BY	DATE	REVISION

FILE 3028.000-Prepares: Wheaton-GR.dwg	SHEET NUMBER
DRAWN BY: TLM	5
DATE: 12-20-24	5829.000
CHECKED BY: A.P.	SCALE: 1" = 10'
DATE: 12-20-24	OF 19 SHEETS












# GRADING PLAN NOTES


- PRIOR TO STARTING ANY CONSTRUCTION, PROVIDE SOIL EROSION AND SEDIMENT CONTROL DEVICES AS SHOWN ON THE PLANS AND AS REQUIRED PER ILLINOIS DEPARTMENT OF TRANSPORTATION NOTES AND DETAILS THROUGHOUT THE ENTIRE PLAN SET.
- PRIOR TO STARTING ANY EXCAVATION WORK, PROVIDE TREE PROTECTION, PRESERVATION AND ROOT PRUNING AS SHOWN ON THE PLANS AND NOTES THROUGHOUT THE ENTIRE PLAN SET.
- CONTRACTOR SHALL REFER TO SUBSURFACE SOIL EXPLORATION REPORT.
- REFER TO GENERAL NOTES FOR GRADING, COMPACTION AND PROOF ROLL REQUIREMENTS.
- HANDICAP ACCESSIBLE PARKING SPACES SHALL BE CONSTRUCTED BETWEEN 1.0% AND 1.90% MAXIMUM SLOPES IN ANY ONE DIRECTION. ILLINOIS ACCESSIBILITY CODE PERMITS A MAXIMUM CONSTRUCTED SLOPE OF 2.00%.
- CRUSHED CONCRETE MAY NOT BE USED FOR THIS PROJECT WITHOUT PRIOR WRITTEN NOTICE FROM THE PROJECT ENGINEER.
- THE CONTRACTOR SHALL IMPORT OR EXPORT SOIL AS NECESSARY TO CONSTRUCT THE SITE TO SPECIFIED PLAN GRADES. SUCH WORK IS CONSIDERED INCIDENTAL TO THE CONTRACT AND NO ADDITIONAL COMPENSATION SHALL BE ALLOWED FOR SUCH WORK. MINOR ADJUSTMENTS TO GRADES CAN BE ACCOMMODATED WITH PROJECT ENGINEER APPROVAL.
- THE CONTRACTOR SHALL INCLUDE ALL ASSOCIATED COSTS WITH THE REMOVAL, TRANSPORT, DISPOSAL, TESTING AND CERTIFICATION OF "UNCONTAMINATED SOIL" AS DEFINED UNDER 415 ILCS 5/3.160 INCLUDING ANY FEES, TAXES, OR SURCHARGES CHARGED BY OR THROUGH THE OPERATOR(S) OF CLEAN CONSTRUCTION OR DEMOLITION DEBRIS FILL OPERATIONS OR UNCONTAMINATED SOIL FILL OPERATIONS FOR THE ACCEPTANCE OF UNCONTAMINATED SOIL.
- REFER TO SOIL EROSION AND SEDIMENT CONTROL NOTES AND DETAILS FOR SEED AND BLANKET REQUIREMENTS FOR TEMPORARY STABILIZATION.
- REFER TO GEOMETRIC PLAN FOR FINAL RESTORATION REQUIREMENTS.
- CONTRACTOR SHALL PROVIDE THE FOLLOWING AS-CONSTRUCTED DOCUMENTS AT THE CONCLUSION OF THE PROJECT:
  - STORMWATER BASINS AND VAULTS
  - OVERFLOW WEIR, AND BOTTOM OF BASIN ELEVATIONS
  - STRUCTURE, PIPE AND FLARED END SECTIONS ELEVATIONS WITHIN BASIN
  - CONTROL STRUCTURE RESTRICTOR SIZE AND ELEVATION
  - AS-CONSTRUCTED VOLUMES WITHIN RESPECTIVE BASINS UP TO OVERFLOW

- ELEVATION.
    - LAWN OR OPEN SPACE AREAS
    - SPOT ELEVATIONS AT A MAXIMUM 50 FOOT GRID.
    - SPOT ELEVATION TOP AND BOTTOM OF BERM OR SWALES
    - SPOT ELEVATIONS ALONG THE ELEVATION / HIGH AND LOW POINTS.
  - PARKING LOT AND HARD SURFACES
    - TOP OF CURB AND FLOWLINE ELEVATIONS AT SIMILAR LOCATIONS TO PROPOSED GRADING.
    - SPOT ELEVATIONS AT SUMMIT / HIGH AND LOW POINTS.
  - ADA PARKING STALLS, SIDEWALK RAMPS, AND ADA ROUTES
    - PROVIDE 6 SPOT ELEVATIONS WITHIN THE PARKING STALL 3 ALONG THE FRONT AND REAR OF THE STALL AT 8 FOOT SPACING ALONG THE STALL PAVEMENT MARKINGS.
    - PROVIDE 4 SPOT GRADES PER SQUARE AT LANDINGS AND ANY TAMPERS OR RAMPS.
    - PROVIDE SPOT ELEVATIONS ALONG ROUTE AT MAXIMUM 10 FOOT SPACING ON BOTH SIDES OF THE PATH TO CONFIRM CROSS AND LONGITUDINAL SLOPES REQUIREMENTS HAVE BEEN MET.
  - BUILDINGS
    - TOP OF FOUNDATION ELEVATIONS.
    - FINISHED FLOOR ELEVATIONS AT DOORWAYS.
- IN PROPOSED PAVEMENT AREAS, STRIP ALL TOPSOIL, EXCAVATE TO SUB-BASE, COMPACT SOIL TO 95% MODIFIED PROCTOR DENSITY (ASTM D-1557) AND INSTALL PAVEMENT SECTION AS NOTED ON THE PLANS. PRIOR TO APPROVAL OF THE SUB-BASE, ALL PAVEMENT AREAS WILL BE PROOF ROLLED. ANY AREAS FOUND TO DEFECT SHALL BE SCARIFIED AND RECOMPACTED AS DIRECTED BY THE ENGINEER, UNTIL THIS STANDARD IS ACHIEVED.
  - REFER TO SHPPP PLAN FOR SEQUENCE OF CONSTRUCTION. NOTE MASS GRADING WORK ZONE AREAS SHALL BE MINIMIZED TO PREVENT EROSION. ONCE A WORK ZONE HAS BEEN ROUGH GRADED, STABILIZE AREA WITH MULCH AND PROCEED TO NEXT WORK AREA UNTIL SITE IS COMPLETED.
  - CONTRACTOR SHALL ENSURE POSITIVE DRAINAGE TO ALL INLETS AND CATCHBASINS. AREAS OF SURFACE PONDING SHALL BE CORRECTED BY THE CONTRACTOR AT NO ADDITIONAL EXPENSE TO THE OWNER.
  - ALL LAWN AREAS DISTURBED AS A RESULT OF CONSTRUCTION SHALL BE RESTORED TO PRECONSTRUCTION LAWN CONDITION FOLLOWING RESTORATION REQUIREMENTS.
  - EXISTING FIRE HYDRANT AND VALVE BOX ADJACENT TO EACH OTHER NEAR THE SOUTHWEST CORNER OF THE SITE SHALL REMAIN AT THEIR EXISTING ELEVATIONS. THE CONTRACTOR SHALL TAKE CARE TO CONSTRUCT PROPOSED SIDEWALK TO ENSURE SMOOTH TRANSITIONS AROUND HYDRANT AND THAT PROPOSED SIDEWALK IS FLUSH WITH VALVE BOX RIM.

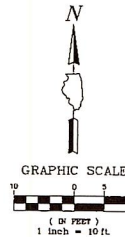

## GRADING LEGEND

- TOP OF CURB FLOW LINE
- PROPOSED SPOT ELEVATION
- CONTOUR
- STRUCTURE ADJUSTMENT
- SUMMITS
- SIDEWALK GRADE BREAK
- SLOPES
- SWALES
- OVERLAND FLOW ROUTE

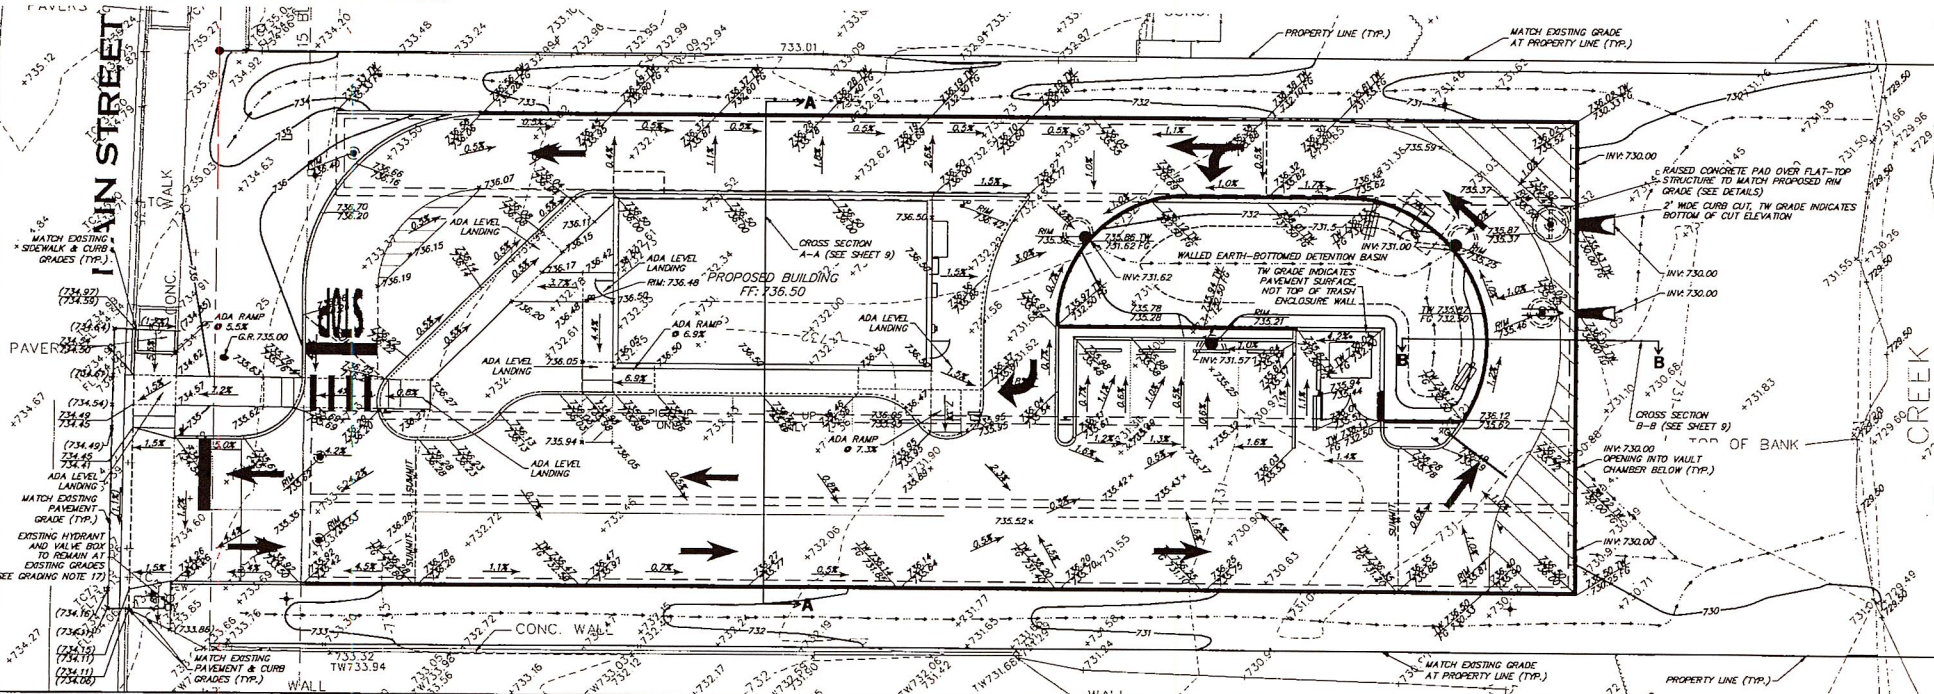

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**GRADING PLAN**  
**POPEYES LOUISIANA KITCHEN**  
**1815 NORTH MAIN STREET**  
**WHEATON, ILLINOIS**

NO. BY	DATE	REVISION	NO. BY	DATE	REVISION

FILE 5828.000-Popeyes Kitchen-GR.dwg

DRAWN BY: TLW

DATE: 12-20-24

CHECKED BY: A.P.

DATE: 12-20-24

GHA PROJECT # 5828.000

SCALE 1" = 10'

SHEET NUMBER **8**

OF 19 SHEETS




## GRADING PLAN CROSS SECTIONS



Figure 1. The effect of the number of trials on the number of correct responses. The number of correct responses (Y-axis) is plotted against the number of trials (X-axis). The data points are connected by a line, and the error bars represent the standard error of the mean. The number of correct responses increases with the number of trials, reaching a plateau around 10 trials.



- [illegible]

- IT WAS APPROVED FULL STABILIZATION, RECOVERED AS REQUIRED TO CONSTRUCT THE IS PLACED UP TO THE CHECK/WETLAND AS INDICATED ON THE PLANS AS LONG AS THE SITE INTO THE WETLAND/CHECK.

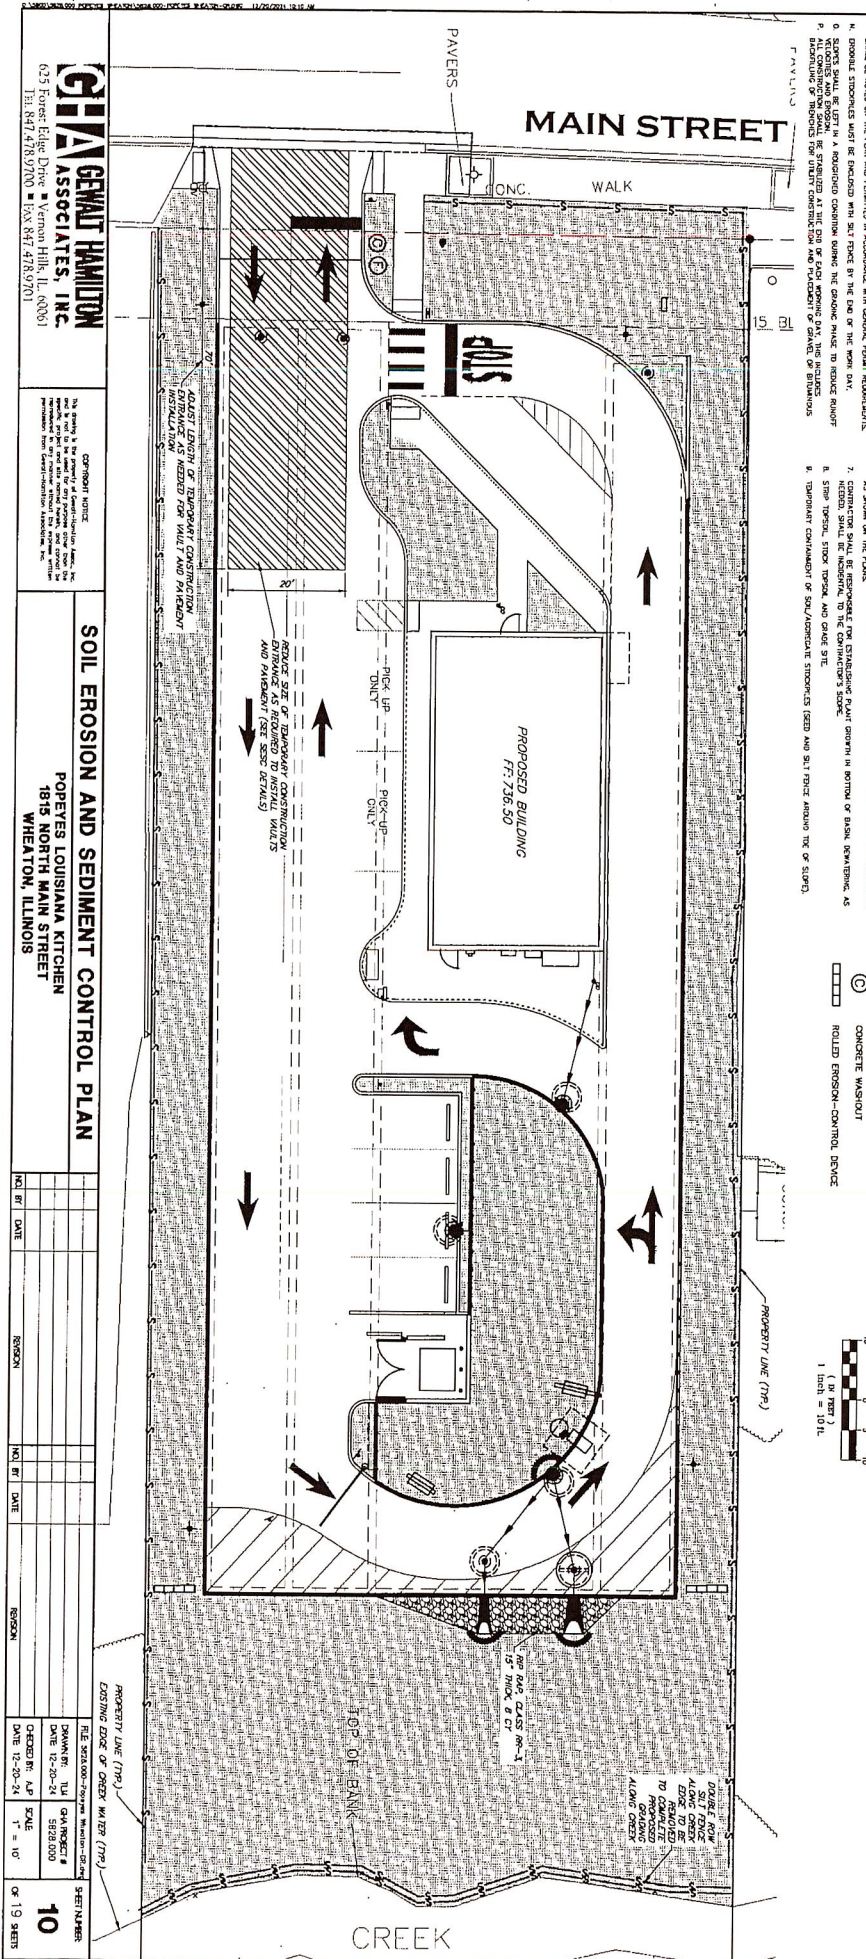

EXISTING EDGE OF DRIVEWAY (17%)

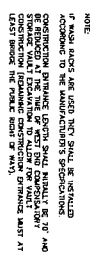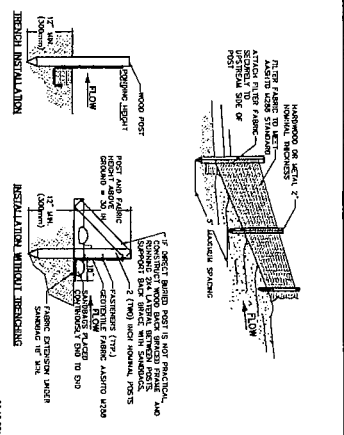

[illegible]

**SILT FENCE INSTALLATION DETAIL**


NOTES

1. ACTUAL LENGTH DETERMINED IN FIELD.
2. THE CONCRETE JOINTS SHALL BE INSTALLED WITHOUT WEATHERING.
3. CONCRETE JOINTS SHALL BE PLACED IN SUCH A MANNER AS TO MINIMIZE THE EFFECTS OF WEATHERING.
4. CONCRETE JOINTS SHALL BE LOCATED AT LEAST 3 FEET FROM THE FACE OF A CURB OR WALL.
5. STEEL BARS SHALL BE TYPICALLY 12" x 12" x 20'00'.
6. CONCRETE JOINTS SHALL BE TYPICALLY 12" x 12" x 20'00'.
7. CONCRETE JOINTS SHALL BE TYPICALLY 12" x 12" x 20'00'.

10' MIN.

12' x 12' x 20'00'

10' MIN.

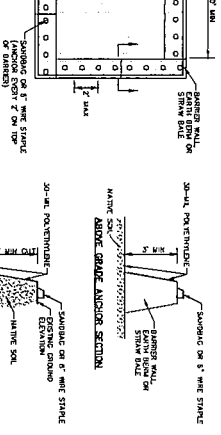

30-141. PAVING/PAVING  
IN VIEW

ADVANTAGE:

PAVED CONCRETE WASTE SHALL BE POURED IN AND COVERED OF  
PARTS WITH 1/4" OF CEMENT IS REQUIRED.

UNPAVED CONCRETE CAN BE PROPERLY RECYCLED AND REUSED

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UNPAVED CONCRETE CAN BE PROPERLY RECYCLED AND REUSED

## CONCRETE WASHOU

[illegible][illegible]



## GENERAL NOTES

- ALL CONSTRUCTION SHALL BE PERFORMED ACCORDING TO THE ILLINOIS DEPARTMENT OF TRANSPORTATION "STANDARD SPECIFICATIONS FOR ROAD AND BRIDGE CONSTRUCTION" LATEST EDITION, THE "SUPPLEMENTAL SPECIFICATIONS AND RECURRING SPECIAL PROVISIONS" LATEST EDITION, THE "STANDARD SPECIFICATIONS FOR WATER AND SEWER MAIN CONSTRUCTION IN ILLINOIS" LATEST EDITION, THE ILLINOIS PLUMBING CODE, THE DETAILS IN THESE PLANS, THE CONTRACT DOCUMENTS, ALL APPLICABLE REQUIREMENTS OF THE ILLINOIS DEPARTMENT OF TRANSPORTATION, THE IEPA AND ORDINANCES OF AUTHORITIES HAVING JURISDICTION AND ALL ADDENDA THERETO.
- EASEMENTS FOR THE EXISTING UTILITIES, BOTH PUBLIC AND PRIVATE AND UTILITIES WITHIN PUBLIC RIGHTS-OF-WAY ARE SHOWN ON THE PLANS ACCORDING TO AVAILABLE RECORDS, THE CONTRACTOR SHALL BE RESPONSIBLE FOR DETERMINING THE EXACT LOCATION IN THE FIELD OF THESE UTILITY LINES AND THEIR PROTECTION FROM DAMAGE DUE TO CONSTRUCTION OPERATIONS. IF EXISTING UTILITY LINES OF ANY NATURE ARE ENCOUNTERED WHICH CONFLICT WITH NEW CONSTRUCTION, THE CONTRACTOR SHALL NOTIFY THE ENGINEER IMMEDIATELY SO THAT THE CONFLICT MAY BE RESOLVED.
- WHENEVER, DURING CONSTRUCTION OPERATIONS, ANY LOOSE MATERIAL IS DEPOSITED IN THE FLOW LINE OF GUTTERS, DRAINAGE STRUCTURES, DITCHES, ETC. SUCH THAT THE NATURAL FLOW LINE OF WATER IS OBSTRUCTED, THE LOOSE MATERIAL WILL BE REMOVED AT THE CLOSE OF EACH WORKING DAY AT THE CONCLUSION OF CONSTRUCTION OPERATIONS, ALL DRAINAGE STRUCTURES AND FLOW LINES SHALL BE FREE FROM DIRT AND DEBRIS. THIS WORK SHALL BE CONSIDERED INCLUDED IN THE CONTRACT. THE CONTRACTOR'S FAILURE TO PROVIDE THE ABOVE WILL PRECLUDE ANY POSSIBLE ADDED COMPENSATION REQUESTED DUE TO DELAYS OR UNSUITABLE MATERIALS CREATED AS A RESULT THEREOF.
- THE CONTRACTOR SHALL VERIFY ALL DIMENSIONS AND EXISTING CONDITIONS AFFECTING THEIR WORK WITH THE ACTUAL CONDITIONS AT THE JOB SITE PRIOR TO ORDERING MATERIALS. IN ADDITION, THE CONTRACTOR MUST VERIFY THE LINE AND GRADES. IF THERE ARE ANY DISCREPANCIES FROM WHAT IS SHOWN ON THE CONSTRUCTION PLANS, STANDARD SPECIFICATIONS AND/OR SPECIAL DETAILS, THE CONTRACTOR SHALL SECURE WRITTEN INSTRUCTION FROM THE ENGINEER PRIOR TO PROCEEDING WITH ANY PART OF THE WORK AFFECTED BY OMISSION OR DISCREPANCIES. FAILURE TO SECURE SUCH INSTRUCTION, THE CONTRACTOR WILL BE CONSIDERED TO HAVE PROCEEDED AT HIS/HER OWN RISK AND EXPENSE AND NO ADDITIONAL COMPENSATION WILL BE PROVIDED FOR ANY COSTS INCURRED.
- ALL PAVEMENT DIMENSIONS ARE SHOWN TO EDGE OF PAVEMENT UNLESS OTHERWISE NOTED.
- WHERE SECTION OR SUBSECTION MONUMENTS ARE ENCOUNTERED, THE ENGINEER SHALL BE NOTIFIED BEFORE THE MONUMENTS ARE REMOVED. THE CONTRACTOR SHALL CAREFULLY PRESERVE ALL PROPERTY MARKS AND MONUMENTS UNTIL THE OWNER, AUTHORIZED SURVEYOR OR AGENT HAS WITNESSED OR OTHERWISE REFERENCED THEIR LOCATION.
- THE CONTRACTOR SHALL NOTIFY THE ENGINEER AT LEAST 72 HOURS PRIOR TO BEGINNING WORK.
- IF DURING CONSTRUCTION THE CONTRACTOR ENCOUNTERS OR OTHERWISE BECOMES AWARE OF ANY SEWERS OR UNDERDRAINS OTHER THAN THOSE SHOWN ON THE PLANS, HE/SHE SHALL INFORM THE ENGINEER, WHO SHALL DIRECT THE WORK NECESSARY TO MAINTAIN OR REPLACE THE FACILITIES IN SERVICE AND TO PROTECT THEM FROM DAMAGE DURING CONSTRUCTION IF MAINTAINED. EXISTING FACILITIES TO BE MAINTAINED THAT ARE DAMAGED BECAUSE OF NON-COMPLIANCE WITH THIS PROVISION SHALL BE REPLACED AT THE CONTRACTOR'S OWN EXPENSE.
- THE CONTRACTOR SHALL PROVIDE TEMPORARY TOILET FACILITIES AND HAND SANITIZING STATIONS FOR THE USE OF ALL THE CONTRACTOR'S PERSONNEL EMPLOYED ON THE WORK SITE. THE FACILITIES SHALL BE MAINTAINED IN PROPER SANITARY CONDITION THROUGHOUT THE PROJECT. THE LOCATION OF THE TEMPORARY FACILITIES SHALL BE APPROVED BY THE ENGINEER.
- THE CONTRACTOR IS RESPONSIBLE FOR COMPLYING WITH THE NPDES PERMIT AND SWPPP MANUAL. IF NO NPDES PERMIT OR SWPPP MANUAL IS NEEDED FOR THE PROJECT THE CONTRACTOR SHALL PERFORM SOIL EROSION SEDIMENT CONTROL, BEST PRACTICES OR AS DIRECTED BY THE OWNER TO PREVENT ILLEGAL DISCHARGES FROM THE SITE.

## UTILITY NOTES

- UNDERGROUND WORK SHALL INCLUDE TRENCHING, DISPOSAL OF EXCESS MATERIAL, DEWATERING, INSTALLATION OF PIPE, CASTINGS, STRUCTURES, BACKFILL OF TRENCHES AND COMPACTION AND TESTING AS SHOWN ON THE CONSTRUCTION PLANS. FITTINGS AND ACCESSORIES NECESSARY TO COMPLETE THE WORK MAY NOT BE SPECIFIED BUT SHALL BE CONSIDERED AS INCLUDED TO THE COST OF THE CONTRACT. ALL SEWER SHALL BE INSTALLED USING A LASER AND BEGIN AT THE DOWNSIDE END.
- SANITARY SERVICE CONNECTIONS TO NEW SEWERS SHALL BE MADE WITH WYE BRANCHES. WYE BRANCHES SHALL BE FACTORY MANUFACTURED PERMANENTLY AFFIXED TO THE MAIN SEWER. TEE BRANCHES ARE NOT ALLOWED.
- ALL CONNECTIONS TO EXISTING OR DISSIMILAR STORM/SANITARY LINES SHALL BE DONE WITH STAINLESS STEEL NON-SHEAR COUPLINGS.
- STONE BEDDING AND BACKFILL SHALL BE OBTAINED FOR A DISTANCE OF 15 FEET UP AND DOWNSIDE OF SEWERS DRAINING TO OR FROM PONDS OR STREAMS. THE REPLACED BEDDING SHALL BE SILTY CLAY SOIL MECHANICALLY COMPACTED TO 90% MODIFIED PROCTOR DENSITY. THE USE OF PERMEABLE SOILS WILL NOT BE PERMITTED.
- ALL WATER MAIN SHALL HAVE MECHANICAL RESTRAINED TIE JOINTS AT ALL CONNECTIONS AND FITTINGS. IN ADDITION, ALL HARDWARE SHALL BE STAINLESS STEEL.
- THRUST BLOCKING SHALL BE PROVIDED ON WATER MAIN AT ALL BENDS, TEES, ELBOWS, ETC. INDIVIDUAL INSPECTION FOR ALL THRUST BLOCKING IS REQUIRED. THRUST BLOCKING SHALL BE POURED IN PLACE CONCRETE. PRECAST BLOCKS MAY BE USED AS APPROVED BY THE ENGINEER IN THE FIELD.
- ALL FLOOR DRAINS SHALL DISCHARGE TO THE SANITARY SEWER, ALL DOWNSPOUTS, SIDE YARD DRAINS, AND OUTSIDE DRAINS SHALL DISCHARGE TO THE STORM SEWER SYSTEM. FOOTING DRAINS SHALL FIRST DRAIN TO A SUMP PIT.

## PROJECT SPECIFIC NOTES

- THE CONTRACTOR SHALL PROVIDE AS-BUILT DRAWINGS THAT INCLUDE: CRITICAL SPOT GRADES SUCH AS OVERFLOW ELEVATIONS, SPOT ELEVATIONS NEAR ENTRANCES, SPOT ELEVATIONS ALONG THE DESIGNATED ADA ROUTE, SUFFICIENT INFORMATION SUCH THAT THE ENGINEER MAY VERIFY DRAINAGE VOLUMES, RIM AND INVERT ELEVATIONS OF ALL SEWERS, RIM AND TOP OF PIPE ELEVATIONS OF ALL WATER MAIN, LOCATIONS OF ALL INSTALLED UNDERGROUND UTILITIES, LOCATIONS OF ALL BURIED BENDS AND FITTINGS AND ALL FIELD CHANGES FROM THE APPROVED DRAWINGS.
- ALL WORK PERFORMED UNDER THIS CONTRACT SHALL BE GUARANTEED BY THE CONTRACTOR AND HIS SURETY FOR A PERIOD OF 12 MONTHS FROM THE DATE OF INITIAL ACCEPTANCE OF THE WORK BY THE OWNER AGAINST ALL DEFECTS IN MATERIALS AND WORKMANSHIP OF WHATEVER NATURE.
- ALL CONSTRUCTION WILL BE INSPECTED BY THE OWNER'S REPRESENTATIVE. ALL WORK SHALL CONFORM TO THE REQUIREMENTS OF THE MUNICIPALITY AS WELL AS THE STANDARD SPECIFICATIONS.
- THE SEWER AND WATER CONTRACTOR SHALL BE REQUIRED TO BE LICENSED AND BONDED WITH THE CITY OF WHEATON BEFORE WORK IS STARTED.
- CONTRACTOR SHALL NOTIFY THE CITY OF WHEATON (830-290-2000) AND THE PROJECT ENGINEER (847-478-9700) AT LEAST 72 HOURS PRIOR TO BEGINNING ANY WORK ON THIS PROJECT.
- THE CONTRACTOR SHALL INDEMNIFY THE OWNER, ENGINEER, THE MUNICIPALITY AND THEIR AGENTS, FROM ALL LIABILITY INVOLVED IN CONSTRUCTION, INSTALLATION AND TESTING OF THE WORK ON THIS PROJECT.
- THE CONTRACTOR MUST CARRY INSURANCE IN ACCORDANCE WITH THE STANDARD SPECIFICATIONS. ALL OFFICIALS, EMPLOYEES AND AGENTS OF GEWALT HAMILTON ASSOCIATES MUST BE LISTED AS ADDITIONAL INSURED.
- ALL ELEVATIONS ARE ON NAVD 88 VERTICAL DATUM.
- THE CONTRACTOR SHALL BE RESPONSIBLE FOR THE INSTALLATION AND MAINTENANCE OF ALL TRAFFIC CONTROL TO ADEQUATELY INFORM AND PROTECT THE PUBLIC OF ALL CONSTRUCTION OPERATIONS.
- STOCKPILING MATERIAL WITHIN THE 100 YEAR FLOOD PLAIN AND OR THE FLOODWAY IS STRICTLY PROHIBITED.
- PRIOR TO PLACEMENT OF FABRIC AND STONE, THE SUBGRADE SHALL BE PROOF-ROLLED IN THE PRESENCE OF THE ENGINEER. PROOF-ROLLING SHALL BE DONE USING A THREE AXLE DUMP TRUCK TOGETHER WITH LOAD WEIGHING AT LEAST TWENTY-FIVE (25) TONS. THE LOAD SHALL BE UNIFORMLY PLACED IN THE DUMP BODY. ALL DEFICIENCIES SHALL BE REPAIRED AND RE-PROOF-ROLLED UNTIL FOUND ACCEPTABLE TO THE ENGINEER.
- CRUSHED CONCRETE IS NOT PERMITTED FOR USE ON THE PROJECT UNLESS PRIOR WRITTEN NOTICE IS GIVEN BY THE ENGINEER.
- ALL STONE USED ON THE PROJECT SHALL BE CRUSHED UNLESS SPECIFICALLY NOTED OTHERWISE.
- ALL CONCRETE SHALL HAVE A LIGHT BROOM FINISH APPLIED WITHIN 1 HOUR OF FINAL STRIKING.
- ALL CONCRETE SHALL CONSIST OF PORTLAND CEMENT CONCRETE MEETING REQUIREMENTS OF SECTION 1020. ALL SIDEWALKS, CURBS AND POST FOUNDATIONS SHALL BE CLASS II 3,500 PSI @ 14 DAYS. ALL PAVEMENT SHALL BE CLASS PV 3,500 PSI @ 14 DAYS. WHERE NOTED ON THE PLANS HIGH EARLY CONCRETE SHALL BE CLASS PV TYPE II 3,500 PSI CONCRETE @ 3 DAYS. ALL CONCRETE REQUIRING A CURE TIME FASTER THAN 3 DAYS SHALL HAVE A MIX DESIGN SUBMITTED TO THE ENGINEER FOR APPROVAL. WHEN REQUIRED BY THE MUNICIPALITY, FLY ASH SHALL NOT BE USED IN THE MIX DESIGN. SLUMP SHALL BE 2-4" AND AIR CONTENT SHALL BE BETWEEN 5-8% UNLESS MODIFIED BY ARTICLE 1020.4.
- ALL CONCRETE SHALL HAVE A WHITE, DOT TYPE 3 CURING COMPOUND APPLIED TO THE SURFACE WITHIN 1 HOUR OF FINAL STRIKING AT THE MANUFACTURER RECOMMENDED APPLICATION RATE.
- 3/4" THICK PRE-MOLDED FIBER EXPANSION JOINTS WITH 2 - 3/4" x 18" PLAIN ROUND, STEEL DOWEL BARS SHALL BE INSTALLED IN ALL CURBS AT (45) FORTY-FIVE FOOT INTERVALS AND AT ALL P.C.'S, P.T.'S AND CURB RETURNS. ALTERNATE ENDS OF THE DOWEL BARS SHALL BE GREASED AND FITTED WITH METAL EXPANSION TUBES. ALL EXPANSION JOINTS MUST BE FREE OF CONCRETE FOR FULL DEPTH. CONTRACTOR JOINTS SHALL BE TOOLED AT 15' INTERVALS.
- UNLESS OTHERWISE NOTED ON THE PLANS WHENEVER NEW CONCRETE ABUTS EXISTING OR NEW CONCRETE SET A 1/2" THICK PRE-MOLDED FIBER EXPANSION JOINT AND DOWEL WITH SMOOTH 12" #4 BARS @ 24" O.C. THIS INCLUDES CONCRETE POURED ADJACENT TO EXISTING SIDEWALKS, CURBS AND BUILDING. THE DOWEL BARS SHOULD BE 4" INTO EXISTING CONCRETE WITH 8" EXTENDING INTO NEW CONCRETE.
- ALL DOWEL BARS AND THE BARS SHALL BE EPOXY COATED UNLESS NOTED OTHERWISE.
- ALL PAVEMENT AND BUILDING SUBGRADE SHALL BE COMPACTED TO 95% MODIFIED PROCTOR DENSITY (ASTM D-1557). ALL SUBGRADE IN LAWN AREAS SHALL BE COMPACTED TO 90% MODIFIED PROCTOR DENSITY (ASTM D-1557). ALL TOPSOIL AND SUBGRADE 6" BELOW TOPSOIL SHALL BE COMPACTED TO 80% STANDARD PROCTOR DENSITY (ASTM D-698).
- SPREAD SCREENED TOPSOIL ON ALL DISTURBED AREAS AND PROPOSED GREEN AREAS. TOPSOIL SHALL COMPLY WITH REQUIREMENTS OF ARTICLE 10B1.05.
- ALL SIGNAGE SHALL BE INSTALLED IN ACCORDANCE WITH THE MOST RECENT VERSION OF THE MANUAL ON UNIFORM TRAFFIC CONTROL DEVICES AND ILLINOIS SUPPLEMENT OR ILLINOIS DEPARTMENT OF TRANSPORTATION DETAILS.
- ALL SIGNAGE NOT ATTACHED TO SIGNAL OR LIGHTING POLES SHALL BE MOUNTED ON TELESCOPING STEEL SIGN SUPPORTS WITH BREAKAWAY BASES IN ACCORDANCE WITH SECTION 728.
- ALL SIGNAGE SHALL HAVE TYPE ZZ SHEETING.

## EROSION CONTROL NOTES

- AT A MINIMUM, THE CONTRACTOR SHALL INSTALL AND MAINTAIN SOIL EROSION AND SEDIMENT CONTROL, BEST MANAGEMENT PRACTICES IN ACCORDANCE WITH THE REQUIREMENTS SET FORTH IN THE LATEST EDITION OF THE ILLINOIS ENVIRONMENTAL PROTECTION AGENCY'S URBAN MANUAL.
- DISTURBED AREAS AND AREAS USED FOR STORAGE OF MATERIALS THAT ARE EXPOSED TO PRECIPITATION SHALL BE INSPECTED FOR EVIDENCE OF, OR THE POTENTIAL FOR, POLLUTANTS ENTERING THE DRAINAGE SYSTEM. WHERE DISCHARGE LOCATIONS OR POINTS ARE ACCESSIBLE, THEY SHALL BE INSPECTED TO ASCERTAIN WHETHER EROSION CONTROL MEASURES ARE EFFECTIVE IN PREVENTING SIGNIFICANT IMPACTS TO RECEIVING WATERS.
- LOCATIONS WHERE VEHICLES ENTER OR EXIT THE SITE SHALL BE INSPECTED FOR EVIDENCE OF OFFSITE SEDIMENT TRACKING. THE CONTRACTOR SHALL BE RESPONSIBLE FOR CLEANING ANY ROAD OF MATERIAL THAT IS FROM THE PROJECT. THIS WILL BE DONE AT THE CLOSE OF EACH DAY OF WORK OR MORE FREQUENTLY AS FIELD CONDITIONS WARRANT.
- ALL STORM WATER STRUCTURES WITH OPEN LOS SHALL BE PROTECTED WITH INLET FILTER BASKETS. DURING CONSTRUCTION, SEDIMENT SHALL BE REMOVED AS NEEDED, AND BASKETS SHALL BE REPAIRED OR REPLACED AS NEEDED.
- AFTER ACHIEVING PERMANENT VEGETATION, ALL EROSION AND SEDIMENT CONTROL DEVICES SHALL BE REMOVED, AND THE DRAINAGE STRUCTURES SHALL BE CLEANED.
- THE CONTRACTOR SHALL KEEP A WATER SOURCE AT THEIR DISPOSAL FOR THE PURPOSE OF WATERING DOWN SOIL ON SITE AND ADJACENT ROADWAYS WHICH OTHERWISE MAY BECOME AIRBORNE.
- THE CONTRACTOR SHALL STABILIZE ALL IDLE, DISTURBED AREAS WITHIN SEVEN DAYS OF CESSATION OF THE CONSTRUCTION ACTIVITIES IN THAT AREA.
- THE CONTRACTOR IS EXPRESSLY ADVISED NOT TO DISTURB AREAS WHICH ARE OUTSIDE THOSE NECESSARY TO PROVIDE THE IMPROVEMENTS AS CALLED FOR IN THE PLANS.
- ALL EROSION CONTROL MEASURES SHALL BE REPLACED IF DAMAGED OR MAINTAINED THROUGHOUT THE LIFE OF THE PROJECT.
- ALL BYPASS CHANNELS, MUST BE CONSTRUCTED SO THAT CHANNEL FLOWS WILL NOT CAUSE EROSION OF EXCAVATED MATERIAL. IN EACH CASE, SEDIMENTATION BASIN MUST BE CONSTRUCTED SO AS TO ALLOW THE SEDIMENT TO SETTLE PRIOR TO THE DOWNSIDE OF THE PROJECT AREA.
- PUMPS MAY BE USED AS BYPASS DEVICES, BUT IN NO CASE WILL THE WATER BE DIVERTED OUTSIDE THE PROJECT LIMIT. ALL PUMPED WATER SHALL BE FREE OF SILT. PUMPING MAY REQUIRE THE USE OF A SEDIMENT CONTAINMENT FILTER BAG AND OTHER SUPPLEMENTAL SEDIMENT CONTROL MEASURES.
- CONCRETE WASHOUT FACILITIES SHALL BE MADE AVAILABLE IF NEEDED, AND PROPERLY MAINTAINED THROUGHOUT THE PROJECT.
- PROPERLY MANAGE ALL MATERIAL STORAGE AREAS, PORTABLE TOILETS, AND EQUIPMENT FUELING, CLEANING, AND MAINTENANCE AREAS TO ENSURE THESE AREAS ARE FREE OF SPILLS, LEAKS, OR OTHER POTENTIAL POLLUTANTS.
- WASTE, CONSTRUCTION DEBRIS, AND BUILDING MATERIALS SHALL BE COLLECTED AND PLACED IN APPROVED RECEPTACLES.

STORM SEWERS	MODEL/SPECIFICATION	STANDARD REQUIREMENTS
PVC SDR 26	PIPE ASTM D-3034	JOINT ASTM D-3112
PIPE CLIM	PIPE ASTM C-443	JOINT ASTM C-443
PAVED AREAS	CLOSED LID	CLOSED LID NEENAH R-1772 (200 LBS)
CURB STRUCTURES	OPEN LID NEENAH R-3281A WIDEN CURB BOX	CLOSED LID N/A
GRASS AREAS	OPEN LID N/A	CLOSED LID NEENAH R-1772
ADJUSTMENT RINGS	CONCRETE	4" MINIMUM 12" MAXIMUM
PIPE BEDDING MATERIAL	CA-11	
TRENCH BACKFILL	CA-8	
WATER MAINS	MODEL/SPECIFICATION	STANDARD REQUIREMENTS
VALVE BOXES	24" TWO PIECE COVER	FLUE ENCLOSED WATER VALVE BOX ADAPTOR (BY ADAPTOR INC.) REQUIRED FOR STABILIZATION (SEE CITY OF WHEATON DETAILS ON SHEET 11)
WATER VALVES	AWWA C-208	REJECT WEDGE GATE VALVE
WATER MAIN FITTINGS	AWWA C-153	ALL FITTINGS MUST BE MANUFACTURED IN THE USA
PIPE BEDDING MATERIAL	CA-11	
TRENCH BACKFILL	1 M.E. BLACK POLY	WRAP AND AWWA C1082/1.5
POLYWRAP	NO LEAD BRASS	MUELLER B-2514, FORD 622-444
CURB BOX	NO LEAD BRASS	MUELLER B-1000
CORROSION VALVE	DOUBLE STRAP SADDLE	MUELLER SS SERIES SS DOLE STRAP, FORD F5323, ROMAC 300
SERVICE SADDLE	TYPE K COPPER	PIPE ASTM B-88
WATER SERVICE PIPE		
SANITARY SEWERS	MODEL/SPECIFICATION	STANDARD REQUIREMENTS
WATER MAIN CLASS	PVC SDR 26	PIPE ASTM D-3034
FRAME & GASKET	PAVED AREAS	CLOSED LID NEENAH R-1772 (200 LBS)
ADJUSTMENT RINGS	CONCRETE	CLOSED LID NEENAH R-1772 (200 LBS)
PIPE BEDDING MATERIAL	CA-11	
TRENCH BACKFILL	CA-8	
JOINT SEAL	CHITEX	ASTM C-692
MANHOLE CONNECTIONS	ASTM C-692	
JOINT WRAP	MAC WRAP	ASTM C-871 TYPE B

TESTING REQUIREMENTS	
WATER MAIN	ALL WATER MAIN SHALL HAVE A PRESSURE AND LEAKAGE TEST PERFORMED IN ACCORDANCE WITH SECTION 412.14 OF STANDARD SPECIFICATIONS FOR WATER AND SEWER CONSTRUCTION IN ILLINOIS. ACCEPT THE PRESSURE DURING THE TESTS SHALL BE EQUAL TO 150PSI.
SANITARY SEWER	ALL SANITARY SEWERS SHALL BE TESTED IN ACCORDANCE WITH THE STANDARD SPECIFICATIONS FOR WATER AND SEWER CONSTRUCTION IN ILLINOIS. ALL ROAD SANITARY SEWER PIPE SHALL BE TESTED BY EITHER METHOD A OR C AS OUTLINED IN SECTION 311.12. ALL FLEXIBLE SANITARY SEWER PIPE SHALL BE TESTED BY METHOD D AND EITHER METHOD A OR C. ALL SANITARY SEWER MUST BE TESTED BY METHOD D. THE CONTRACTOR SHALL PROVIDE THE ENGINEER A COPY OF THE VIDEO ON A DIGITAL VIDEO DISC. THE VIDEO MUST BE IN COLOR AND PROCEED NO FASTER THAN 1 FOOT PER SECOND.
SEWER WATER MAIN CROSSINGS	ALL SEWERS THAT CROSS OR RUN PARALLEL TO WATER MAINS SUBJECT TO REPAIR REQUIREMENTS FOR WATER MAIN QUALITY PIPE MUST BE PRESURE TESTED ACCORDING TO 412.14 OF THE STANDARD SPECIFICATIONS FOR WATER AND SEWER CONSTRUCTION IN ILLINOIS.
SANITARY MANHOLES	ALL SANITARY MANHOLES SHALL BE TESTED BY EITHER ASTM C-692 OR ASTM C-1244

NON-WOVEN	STYLE DESCRIPTION	STANDARD REQUIREMENTS	RECOMMENDED PRODUCTS
MEDIUM DUTY	UNDERDRAIN FABRIC	8 OZ	
		MINIMUM GRID TENSILE ASTM D482 = 180 LBS	PROFEX GEOTEXT 801
		MINIMUM TENSILE TO AIR ASTM D4833 = 10 LBS	US FABRICS 1600W
		MINIMUM FLOW RATE ASTM D4841 = 110 GAL/IN/24H	THIRKIE LEO 100T
			TENACATE WRAP 120N

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**GENERAL NOTES**  
**POPEYES LOUISIANA KITCHEN**  
**1815 NORTH MAIN STREET**  
**WHEATON, ILLINOIS**

FILE 5628.000-Planets Wheaton-DT.dwg	SHEET NUMBER
DRAWN BY: TLM	QHA PROJECT # 5628.000
DATE: 12-20-24	
CHECKED BY: AJP	SCALE
DATE: 12-20-24	N.A.
	OF 19 SHEETS

**12**








NOTES:

- MATERIALS**
1. WHEEL STOPS: PRECAST, 3,500 MINIMUM AIR-ENTRAINED CONCRETE, 4000 PSI MINIMUM COMPRESSIVE STRENGTH. EACH STOP SHALL BE REINFORCED WITH TWO NO.4 DEFORMED STEEL REINFORCING BARS. MINIMUM PROVIDE CHAMFERED CORNERS AND DRAIN SLOTS ON UNDERSIDE AND PROVIDE HOLES FOR DOWEL-ANCHORING TO SUBSTRATE.
  2. ADHESIVE FOR ANCHORING STOPS TO PARKING STRUCTURE SLABS, AT-GRADE CONCRETE PAVEMENTS, EPoxy ADHESIVE MANUFACTURED FOR THE PURPOSE.
  3. ADHESIVE FOR BONDING DOWEL TO WHEEL STOP, AS PROPOSED BY CONTRACTOR AND APPROVED BY ENGINEER, SUITABLE FOR APPLICATION.
  4. STEEL BARS FOR INSTALLATION: GALVANIZED #5 STEEL DOWELS OR GALVANIZED NO. 5 STEEL REINFORCING BARS.

- INSTALLATION**
1. WHEEL STOPS TO BE CENTERED IN WIDTH OF PARKING STALL.
  2. SECURELY ATTACH WHEEL STOPS INTO AT-GRADE CONCRETE WITH NOT LESS THAN TWO GALVANIZED STEEL DOWELS EMBEDDED IN HOLES CAST INTO WHEEL STOPS, FIRMLY BOND EACH DOWEL TO WHEEL STOP AND TO PAVEMENT.
  3. AT CONCRETE PAVEMENT, DRILL HOLES IN PAVEMENT FOR DOWELS.
  4. AT PARKING STRUCTURE SLABS, EPoxy TO SLAB.

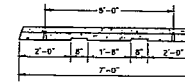


**GHA GEWALT HAMILTON ASSOCIATES, INC.**

WHEEL STOP

NOTES:

1. SET 1/2" EXPANSION JOINTS AT POINTS ADJUTING CURB OR PAVEMENT AND AT 60' MAX. INTERVALS.
2. CONTROL JOINTS SHALL BE 1/8" TO 1/4" WIDE AND 1/4" OF THE SIDEWALK THICKNESS DEEP. THE EDGE OF THE CONTROL JOINTS SHALL BE GIVE A 1/4" RADIUS.
3. SIDEWALK WIDTH AS SHOWN ON PLANS.
4. SIDEWALK JOINTS SHALL MATCH CURB CONTROL AND CONSTRUCTION JOINTS.

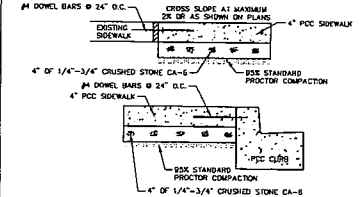

**GHA GEWALT HAMILTON ASSOCIATES, INC.**

PCC SIDEWALK DETAIL

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**DETAILS**  
**POPEYES LOUISIANA KITCHEN**  
**1815 NORTH MAIN STREET**  
**WHEATON, ILLINOIS**

NO.	DATE	REVISION	NO.	DATE	REVISION

FILE 3628.000-Popeyes Wheaton-07.dwg	SHEET NUMBER
DRAWN BY: TLK DATE: 12-20-24	GHA PROJECT # 5828.000
CHECKED BY: A.P. DATE: 12-20-24	SCALE N.A.
	14 OF 19 SHEETS




OF 19 SHEET



# NOTES:


SEE STORM TABLE AND TYPE A MANHOLE DETAIL FOR FURTHER REQUIREMENTS.

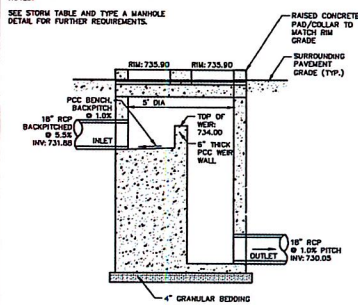

**GHA GEWALT HAMILTON ASSOCIATES, INC.**

## OVERFLOW WEIR SS#13

NOTE: SEE SANITARY TABLE FOR MATERIAL REQUIREMENTS.

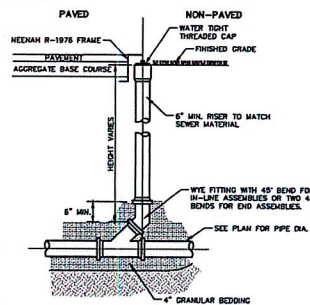

**GHA GEWALT HAMILTON ASSOCIATES, INC.**

## SANITARY SEWER CLEAN-OUT DETAIL

# WAGATE®

## WaGate Flap Valve

KN NPS 8"-24"

Use:  
Used as flood protection and emergency shutdown.  
For mounting on outlet pipes in ducting or from pump station. For stormwater and wastewater.


- Pipe insert with 2 rubber rings for sealing against existing piping.
- Can be mounted below the water surface.
- The flap has a 15 degree inclination.
- Corrosion-proof materials.
- UV-resistant.

### Material

Valve pipe: PE 100  
Flap: PEHD 500 UV-resistant  
Hinges: EP 402/5 3-15 LD rubber  
Seal against flap: EPDM  
Suet EN 14004

### Technical data

Waterproof for one-sided water pressure  
Max pressure: 0.5 psi  
Temperature: -50°C - +80°C

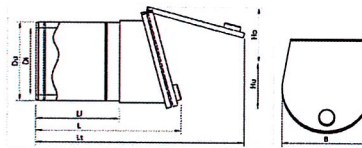

### Dimensions [in] and weight [lbs]


NPS	Ø	L	B	H	R	Wt	Wt	Wt
8	8	73-79	164	6.5	7.9	15.5	20.9	10.7
9	9	81-89	184	7.2	7.9	15.8	22.1	11.6
10	10	93-108	205	8.1	9.9	18.5	25.6	12.8
11	11	98-111	230	9.1	9.9	19.5	26.4	14
12	12	112-124	258	10.2	11.8	19.7	29.9	15.9
14	14	126-141	291	11.5	11.8	24.8	30.5	17.6
16	16	143-158	327	12.9	15.8	28.7	37	19.7
18	18	159-177	369	14.5	17.7	31.5	42.5	22.8
20	20	173-197	409	16.1	19.7	35.4	46.3	23.1
22	22	197-221	458	18	22.1	38.6	51.2	27.3
24	24	224-248	516	20.3	23.6	40.1	57.5	30.1

Other dimensions as required.  
The right to change is reserved.

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1-800-727-6027

**WAPRO**


# TYPICAL INSTALLATION STORM SEWER RESTRICTOR

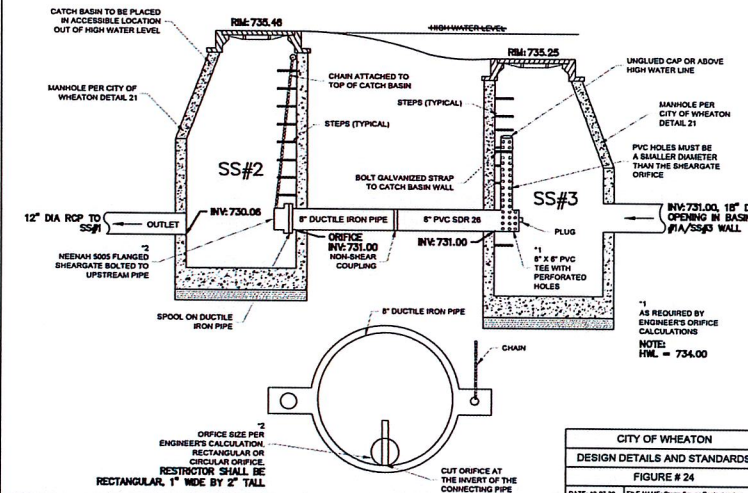

## SANITARY MANHOLE

### NOTES:

- Sanitary Manhole castings
  - In paved and pathway areas Hoesch R-1772 (380 lbs.) with a solid lid.
  - In backlot areas Hoesch R-1772 (225 lbs.).
- All frames and lids must have concealed pick holes and gasketed self-sealing features. "O" ring seals are not permitted. Flat gaskets "T" style (see drawing), and frame must accommodate chimney seal.
- All lids must be stamped "Sanitary Manhole".
- Manholes to have one piece integral base and barrel section.
- Manholes to be 4' diameter for sewers 18" or less, and 5' diameter for sewers larger than 18" and less than 48".
- Manholes 4' in diameter which exceed a depth of 4' shall have steps to be casted with polypropylene plastic. "Presto Fit" type installation. Steps shall be 18" apart on center.
- All Manholes to have chimney seal collars.
- All joints between barrel sections shall be sealed with flexible butyl mastic material 1/2" wide by 1/2" thick. All points between man rings and frames to be sealed with flexible butyl mastic material 25" wide 1/2" thick.
- External or internal chimney seals must be installed between the dome and frame.
- All connections to be by pre-installed synthetic rubber sleeve with stainless steel clamps, non shear-type.
- When shimming to grade is required in paved areas, beveled rubber adjustment rings and butyl mastic shall be used. No shimming of any kind or mortar layers are allowed.
- The maximum amount of adjustment for frame elevation is 8" with 3 man rings. Concrete adjusting rings shall have a minimum thickness of 2". Rubber adjusting rings shall extend no more than 2". Beveled man rings shall be used in cases where a difference in elevation exists. Initial clear rings are not allowed and bricks shall not be used for shimming the frame on the structure.
- When an eccentric cone is used:
  - If the manhole is 4' dia, then the cone shall be of 2'-4" in height.
  - If the manhole is of 5' dia, then the cone shall be of 2'-6" in height.

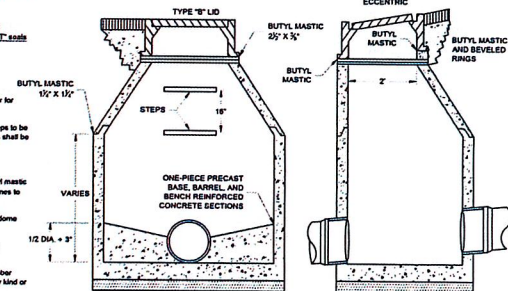

CITY OF WHEATON  
DESIGN DETAILS AND STANDARDS  
FIGURE # 16  
DATE: 12-07-20 FILE NAME: Sanitary Manhole.dwg

**GHA GEWALT HAMILTON ASSOCIATES, INC.**  
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**DETAILS**  
POPEYES LOUISIANA KITCHEN  
1815 NORTH MAIN STREET  
WHEATON, ILLINOIS

FILE: S028.000-Popeyes Wheaton-D1.dwg	SHEET NUMBER:
DRAWN BY: TJA	GHA PROJECT # 5828.000
DATE: 12-20-24	
CHECKED BY: AJP	SCALE: N.A.
DATE: 12-20-24	OF 19 SHEETS

16




## VALVE BOX SETTER



### Valve Box Adaptor II

- ADVANTAGES**
- Eliminates setting and shifting of the valve box over the Gate Valve.
  - Allows proper keying of the valve.
  - Protects epoxy coating on valves.
  - Centers valve box over operating nut.
  - Seals valve box with a resilient material.
  - Cost Effective

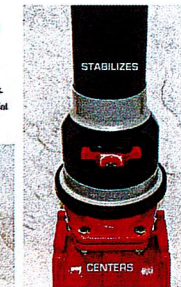


CITY OF WHEATON  
DESIGN DETAILS AND STANDARDS  
FIGURE # 32  
DATE: 12-07-20 FILE NAME: Valve Box Setter 1.dwg

## VALVE BOX SETTER

### Valve Box Adaptor II Detail Specifications

All valve boxes shall be installed upon the valve with the use of a Valve Box Adaptor II as manufactured by Adaptor Inc. or an approved equal.  
The VBS-II shall be installed in lieu of hardscaping and shall be incidental to the valve and box installation.  
Manufactured from recycled "Green" natural rubber.

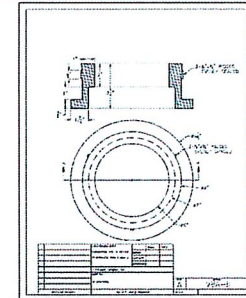


AMERICAN MADE PRODUCTS

WWW.ADAPTORINC.COM


CITY OF WHEATON  
DESIGN DETAILS AND STANDARDS  
FIGURE # 33  
DATE: 12-07-20 FILE NAME: Valve Box Setter 2.dwg

## SANITARY SEWER SERVICE LATERAL DETAIL

A MINIMUM 24-HOUR NOTICE IS REQUIRED PRIOR TO SCHEDULING AN INSPECTION

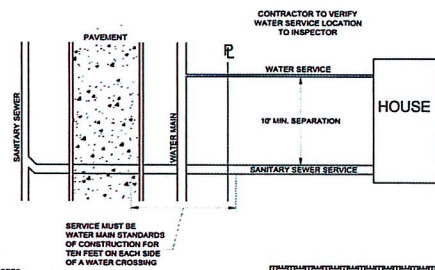


- NOTES:**
1. THE CONNECTION TO THE SEWER SHALL BE MADE WITH A "WYE," AS WITNESSED BY THE INSPECTOR. ALL COUPLERS USED SHALL BE OF A BOX-SHEAR TYPE.
  2. THE SLOPE OF THE SERVICE LINE SHALL BE NO LESS THAN 1%.
  3. THERE SHALL BE A MINIMUM COVER OF 4 FEET.
  4. ALL NEW SERVICE LATERALS MUST INSTALL A CLEANOUT ON PRIVATE PROPERTY OR AS DIRECTED BY THE CITY ENGINEER.
  5. A MINIMUM OF ONE CLEANOUT SHALL BE INSTALLED ON ALL NEW SERVICE LATERALS. THE CLEANOUT SHALL BE THE SAME DIAMETER AS THE SERVICE LATERAL AND MUST BE LOCATED ON PRIVATE PROPERTY.

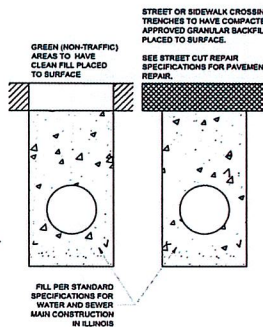

CITY OF WHEATON  
DESIGN DETAILS AND STANDARDS  
FIGURE # 15  
DATE: 12-07-20 FILE NAME: Sanitary Sewer Lateral Detail.dwg

## WATER SERVICE CONNECTION DETAIL

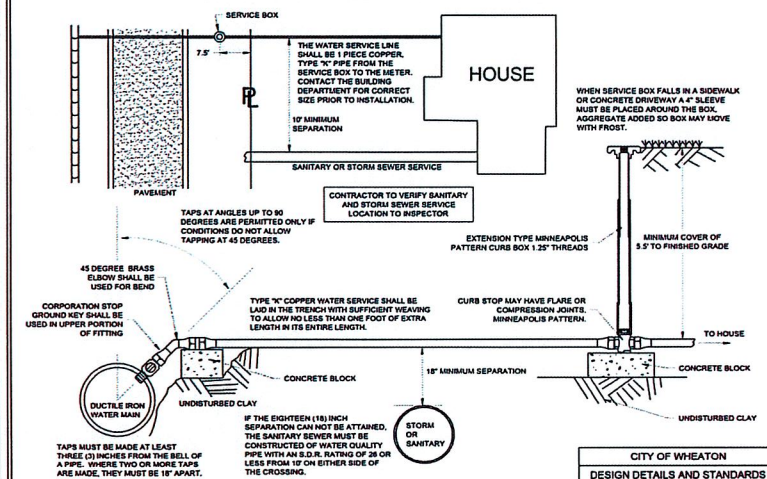

CITY OF WHEATON  
DESIGN DETAILS AND STANDARDS  
FIGURE # 31  
DATE: 12-07-20 FILE NAME: Water Service.dwg

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TEL 847.478.9700 ■ FAX 847.478.9701

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**DETAILS**  
POPEYES LOUISIANA KITCHEN  
1815 NORTH MAIN STREET  
WHEATON, ILLINOIS

FILE: 5828.000-Popeyes Wheaton-DT.dwg	SHEET NUMBER
DRAWN BY: TJA	17
DATE: 12-20-24	OF 19 SHEETS
CHECKED BY: ALP	
DATE: 12-20-24	
SCALE: N.A.	




NO.	DESCRIPTION	QUANTITY	UNIT
1	Grass Sod	7.24	Sq. Yd.
2	Grass Sod	7.24	Sq. Yd.
3	Grass Sod	7.24	Sq. Yd.
4	Grass Sod	7.24	Sq. Yd.
5	Grass Sod	7.24	Sq. Yd.
6	Grass Sod	7.24	Sq. Yd.
7	Grass Sod	7.24	Sq. Yd.
8	Grass Sod	7.24	Sq. Yd.
9	Grass Sod	7.24	Sq. Yd.
10	Grass Sod	7.24	Sq. Yd.
11	Grass Sod	7.24	Sq. Yd.
12	Grass Sod	7.24	Sq. Yd.
13	Grass Sod	7.24	Sq. Yd.
14	Grass Sod	7.24	Sq. Yd.
15	Grass Sod	7.24	Sq. Yd.
16	Grass Sod	7.24	Sq. Yd.
17	Grass Sod	7.24	Sq. Yd.
18	Grass Sod	7.24	Sq. Yd.
19	Grass Sod	7.24	Sq. Yd.
20	Grass Sod	7.24	Sq. Yd.
21	Grass Sod	7.24	Sq. Yd.
22	Grass Sod	7.24	Sq. Yd.
23	Grass Sod	7.24	Sq. Yd.
24	Grass Sod	7.24	Sq. Yd.
25	Grass Sod	7.24	Sq. Yd.
26	Grass Sod	7.24	Sq. Yd.
27	Grass Sod	7.24	Sq. Yd.
28	Grass Sod	7.24	Sq. Yd.
29	Grass Sod	7.24	Sq. Yd.
30	Grass Sod	7.24	Sq. Yd.
31	Grass Sod	7.24	Sq. Yd.
32	Grass Sod	7.24	Sq. Yd.
33	Grass Sod	7.24	Sq. Yd.
34	Grass Sod	7.24	Sq. Yd.
35	Grass Sod	7.24	Sq. Yd.
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41	Grass Sod	7.24	Sq. Yd.
42	Grass Sod	7.24	Sq. Yd.
43	Grass Sod	7.24	Sq. Yd.
44	Grass Sod	7.24	Sq. Yd.
45	Grass Sod	7.24	Sq. Yd.
46	Grass Sod	7.24	Sq. Yd.
47	Grass Sod	7.24	Sq. Yd.
48	Grass Sod	7.24	Sq. Yd.
49	Grass Sod	7.24	Sq. Yd.
50	Grass Sod	7.24	Sq. Yd.

NO.	DESCRIPTION	QUANTITY	UNIT
1	Grass Sod	7.24	Sq. Yd.
2	Grass Sod	7.24	Sq. Yd.
3	Grass Sod	7.24	Sq. Yd.
4	Grass Sod	7.24	Sq. Yd.
5	Grass Sod	7.24	Sq. Yd.
6	Grass Sod	7.24	Sq. Yd.
7	Grass Sod	7.24	Sq. Yd.
8	Grass Sod	7.24	Sq. Yd.
9	Grass Sod	7.24	Sq. Yd.
10	Grass Sod	7.24	Sq. Yd.
11	Grass Sod	7.24	Sq. Yd.
12	Grass Sod	7.24	Sq. Yd.
13	Grass Sod	7.24	Sq. Yd.
14	Grass Sod	7.24	Sq. Yd.
15	Grass Sod	7.24	Sq. Yd.
16	Grass Sod	7.24	Sq. Yd.
17	Grass Sod	7.24	Sq. Yd.
18	Grass Sod	7.24	Sq. Yd.
19	Grass Sod	7.24	Sq. Yd.
20	Grass Sod	7.24	Sq. Yd.
21	Grass Sod	7.24	Sq. Yd.
22	Grass Sod	7.24	Sq. Yd.
23	Grass Sod	7.24	Sq. Yd.
24	Grass Sod	7.24	Sq. Yd.
25	Grass Sod	7.24	Sq. Yd.
26	Grass Sod	7.24	Sq. Yd.
27	Grass Sod	7.24	Sq. Yd.
28	Grass Sod	7.24	Sq. Yd.
29	Grass Sod	7.24	Sq. Yd.
30	Grass Sod	7.24	Sq. Yd.
31	Grass Sod	7.24	Sq. Yd.
32	Grass Sod	7.24	Sq. Yd.
33	Grass Sod	7.24	Sq. Yd.
34	Grass Sod	7.24	Sq. Yd.
35	Grass Sod	7.24	Sq. Yd.
36	Grass Sod	7.24	Sq. Yd.
37	Grass Sod	7.24	Sq. Yd.
38	Grass Sod	7.24	Sq. Yd.
39	Grass Sod	7.24	Sq. Yd.
40	Grass Sod	7.24	Sq. Yd.
41	Grass Sod	7.24	Sq. Yd.
42	Grass Sod	7.24	Sq. Yd.
43	Grass Sod	7.24	Sq. Yd.
44	Grass Sod	7.24	Sq. Yd.
45	Grass Sod	7.24	Sq. Yd.
46	Grass Sod	7.24	Sq. Yd.
47	Grass Sod	7.24	Sq. Yd.
48	Grass Sod	7.24	Sq. Yd.
49	Grass Sod	7.24	Sq. Yd.
50	Grass Sod	7.24	Sq. Yd.

NO.	DESCRIPTION	QUANTITY	UNIT
1	Grass Sod	7.24	Sq. Yd.
2	Grass Sod	7.24	Sq. Yd.
3	Grass Sod	7.24	Sq. Yd.
4	Grass Sod	7.24	Sq. Yd.
5	Grass Sod	7.24	Sq. Yd.
6	Grass Sod	7.24	Sq. Yd.
7	Grass Sod	7.24	Sq. Yd.
8	Grass Sod	7.24	Sq. Yd.
9	Grass Sod	7.24	Sq. Yd.
10	Grass Sod	7.24	Sq. Yd.
11	Grass Sod	7.24	Sq. Yd.
12	Grass Sod	7.24	Sq. Yd.
13	Grass Sod	7.24	Sq. Yd.
14	Grass Sod	7.24	Sq. Yd.
15	Grass Sod	7.24	Sq. Yd.
16	Grass Sod	7.24	Sq. Yd.
17	Grass Sod	7.24	Sq. Yd.
18	Grass Sod	7.24	Sq. Yd.
19	Grass Sod	7.24	Sq. Yd.
20	Grass Sod	7.24	Sq. Yd.
21	Grass Sod	7.24	Sq. Yd.
22	Grass Sod	7.24	Sq. Yd.
23	Grass Sod	7.24	Sq. Yd.
24	Grass Sod	7.24	Sq. Yd.
25	Grass Sod	7.24	Sq. Yd.
26	Grass Sod	7.24	Sq. Yd.
27	Grass Sod	7.24	Sq. Yd.
28	Grass Sod	7.24	Sq. Yd.
29	Grass Sod	7.24	Sq. Yd.
30	Grass Sod	7.24	Sq. Yd.
31	Grass Sod	7.24	Sq. Yd.
32	Grass Sod	7.24	Sq. Yd.
33	Grass Sod	7.24	Sq. Yd.
34	Grass Sod	7.24	Sq. Yd.
35	Grass Sod	7.24	Sq. Yd.
36	Grass Sod	7.24	Sq. Yd.
37	Grass Sod	7.24	Sq. Yd.
38	Grass Sod	7.24	Sq. Yd.
39	Grass Sod	7.24	Sq. Yd.
40	Grass Sod	7.24	Sq. Yd.
41	Grass Sod	7.24	Sq. Yd.
42	Grass Sod	7.24	Sq. Yd.
43	Grass Sod	7.24	Sq. Yd.
44	Grass Sod	7.24	Sq. Yd.
45	Grass Sod	7.24	Sq. Yd.
46	Grass Sod	7.24	Sq. Yd.
47	Grass Sod	7.24	Sq. Yd.
48	Grass Sod	7.24	Sq. Yd.
49	Grass Sod	7.24	Sq. Yd.
50	Grass Sod	7.24	Sq. Yd.

- ### PLANTING NOTES
1. TREE PLANTINGS ARE THE PROPERTY OF THE LANDSCAPE ARCHITECT. THE LANDSCAPE ARCHITECT SHALL BE RESPONSIBLE FOR THE PROTECTION OF THE PLANTINGS FROM DAMAGE BY OTHERS. THE LANDSCAPE ARCHITECT SHALL BE RESPONSIBLE FOR THE PROTECTION OF THE PLANTINGS FROM DAMAGE BY OTHERS.
  2. PLANTING BEDS SHALL BE GRADED OUT TO THE PROPER FINISH GRADE. THE LANDSCAPE ARCHITECT SHALL BE RESPONSIBLE FOR THE PROTECTION OF THE PLANTINGS FROM DAMAGE BY OTHERS.
  3. PLANTING BEDS SHALL BE GRADED OUT TO THE PROPER FINISH GRADE. THE LANDSCAPE ARCHITECT SHALL BE RESPONSIBLE FOR THE PROTECTION OF THE PLANTINGS FROM DAMAGE BY OTHERS.
  4. PLANTING BEDS SHALL BE GRADED OUT TO THE PROPER FINISH GRADE. THE LANDSCAPE ARCHITECT SHALL BE RESPONSIBLE FOR THE PROTECTION OF THE PLANTINGS FROM DAMAGE BY OTHERS.
  5. PLANTING BEDS SHALL BE GRADED OUT TO THE PROPER FINISH GRADE. THE LANDSCAPE ARCHITECT SHALL BE RESPONSIBLE FOR THE PROTECTION OF THE PLANTINGS FROM DAMAGE BY OTHERS.
  6. PLANTING BEDS SHALL BE GRADED OUT TO THE PROPER FINISH GRADE. THE LANDSCAPE ARCHITECT SHALL BE RESPONSIBLE FOR THE PROTECTION OF THE PLANTINGS FROM DAMAGE BY OTHERS.
  7. PLANTING BEDS SHALL BE GRADED OUT TO THE PROPER FINISH GRADE. THE LANDSCAPE ARCHITECT SHALL BE RESPONSIBLE FOR THE PROTECTION OF THE PLANTINGS FROM DAMAGE BY OTHERS.

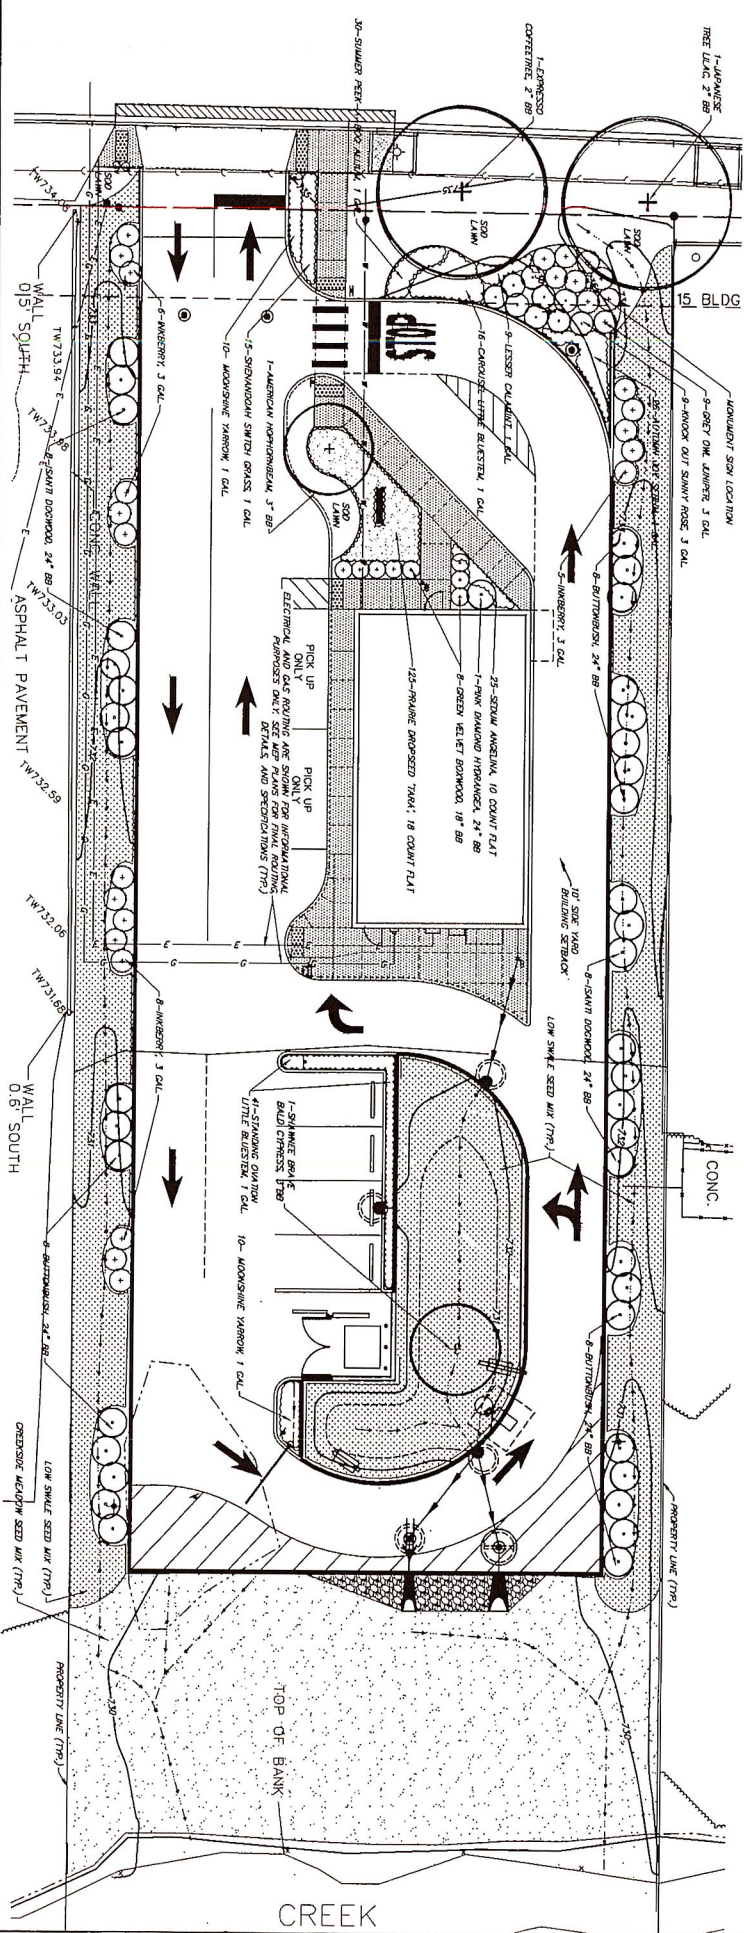

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**LANDSCAPE PLAN**  
POPEYES LOUISIANA KITCHEN  
1815 NORTH MAIN STREET  
WHEATON, ILLINOIS

NO.	DATE	REVISION	NO.	DATE	REVISION
1	12-11-24		2	12-11-24	
3	12-11-24		4	12-11-24	
5	12-11-24		6	12-11-24	
7	12-11-24		8	12-11-24	
9	12-11-24		10	12-11-24	
11	12-11-24		12	12-11-24	
13	12-11-24		14	12-11-24	
15	12-11-24		16	12-11-24	
17	12-11-24		18	12-11-24	
19	12-11-24		20	12-11-24	
21	12-11-24		22	12-11-24	
23	12-11-24		24	12-11-24	
25	12-11-24		26	12-11-24	
27	12-11-24		28	12-11-24	
29	12-11-24		30	12-11-24	
31	12-11-24		32	12-11-24	
33	12-11-24		34	12-11-24	
35	12-11-24		36	12-11-24	
37	12-11-24		38	12-11-24	
39	12-11-24		40	12-11-24	
41	12-11-24		42	12-11-24	
43	12-11-24		44	12-11-24	
45	12-11-24		46	12-11-24	
47	12-11-24		48	12-11-24	
49	12-11-24		50	12-11-24	







